

MINUTES - PLAN COMMISSION

DATE: January 15, 2026
TIME: 6:00 P.M.
LOCATION: City Council Chambers, Kiel City Hall
621 Sixth St., Kiel, Wis.
MEMBERS: Mayor Bob Hennings, Alderperson Bill Krueger,
Pete Tarnowski, Jim Fromm, John Moritz, Eric
Volland, Gina Ziegelbauer

- 1) Mayor Bob Hennings called the meeting to order at 6:00 p.m.
- 2) Pledge of Allegiance
- 3) Roll Call – Members Tarnowski, Ziegelbauer, Krueger, and Fromm were in attendance.
Members Moritz and Volland were excused. Citizen Eddie Arnold was also in attendance.
- 4) Public Comment – Eddie Arnold (458B Jasper Ct) spoke about his request for amending the accessory structure ordinance to allow properties, like his, to have larger accessory structures on their lots.
- 5) Tarnowski moved, seconded by Fromm, to approve the minutes of the December 4, 2025, Plan Commission Meeting. Motion passed unanimously.
- 6) Ziegelbauer moved, seconded by Fromm, to amend ordinance 17.32(2) Accessory Structures related to size permitted for duplex/multi-family properties and recommendation to the City Council. Voting Aye were Tarnowski, Ziegelbauer, and Fromm. Voting Nay was Krueger. Motion carried 3-1.
- 7) Tarnowski moved, Ziegelbauer seconded to amend Chapter 17 of the Kiel Municipal Code by creating Section 17.44, “Administration”. Voting Aye were Tarnowski, Ziegelbauer, Krueger, and Fromm. Motion passed 4-0.
- 8) No date was set for a public hearing.

9) Fromm moved, seconded by Tarnowski to adjourn at 6:27 p.m.

Bob Hennings, Mayor

Prepared by Ryan Pafford, City Administrator

TRINITY EVANGELICAL LUTHERAN CHURCH PROJECT NARRATIVE

Project Description

Trinity Evangelical Lutheran Church is proposing a building addition and associated site improvements at its existing campus located at 387 Cemetery Road in the City of Kiel, Manitowoc County, Wisconsin.

The project is intended to accommodate expanded ministry and educational needs while improving site circulation, parking capacity, and stormwater management. The proposed improvements are designed to integrate with the existing church facilities and surrounding land uses, while meeting applicable City of Kiel, Manitowoc County, and Wisconsin Department of Natural Resources requirements.

Existing Site Conditions

The property is currently developed with an existing church, school, gymnasium, associated parking areas, driveways, sidewalks, and landscaped areas. Access to the site is provided from Cemetery Road. The site contains existing stormwater conveyance features, including roadside ditches, culvert pipes, and catch basins that ultimately discharge to downstream drainage systems. The surrounding land uses consist primarily of agricultural and industrial.

Proposed Development

The project includes the following primary components:

Building Addition:

A new 8,500± SF addition connected to the existing church facility to support expanded cafeteria, conference, office, and support spaces. The addition is architecturally compatible with the existing structure, using similar materials and finishes.

Storage Shed:

A new 1,250± SF storage shed proposed next to the gymnasium for additional storage space.

Bleachers:

Bleachers to be replaced within the gymnasium.

Parking and Circulation Improvements:

The site plan proposes reconfiguration and expansion of paved parking areas to better serve the increased use of the facility.

Existing parking stalls: 146

Additional parking stalls: 94

Total parking stalls upon completion: 240

Pavement improvements include new asphalt paving, pavement milling and overlay of the existing parking lot, expanded asphalt parking lot, updated striping, and designated accessible parking stalls. Internal vehicle circulation has been improved to enhance safety and efficiency.

Driveway and Access Modifications:

An existing driveway and culvert along Cemetery Road will be removed and replaced to the south with a new relocated driveway and culvert designed to improve traffic flow and drainage.

Land Area Adjustment:

The project includes the acquisition of additional land to accommodate the site expansion, with approximately 0.96 acres included in the land purchase area.

Stormwater Management:

Stormwater management improvements are a key component of the project. The site will see an increase of approximately 0.56 acres of impervious surface. Drainage improvements include:

New and modified culvert pipes, apron endwalls, and storm sewer piping.
Re-grading of ditch lines and on-site drainage features to maintain positive drainage.
Stormwater conveyance designed to safely pass runoff without adverse impacts to adjacent properties.

Stormwater facilities are designed in accordance with Wisconsin DNR requirements and applicable local regulations, ensuring post-development runoff conditions are appropriately managed.

Erosion Control:

Temporary and permanent erosion control measures will be implemented during and after construction, including:

Silt fencing and inlet protection.
Construction tracking pads to prevent sediment from being tracked onto public roadways.
Temporary and permanent seeding, mulching, and erosion control blankets where required.
Regular inspections and maintenance of erosion control measures until final stabilization is achieved.

All erosion control practices will comply with Wisconsin Administrative Code NR 216 and WDNR Conservation Practice Standards.

Utilities:

The project will continue to be served by existing public utilities, including water, sanitary sewer, electric, gas, and telecommunications. Any utility adjustments required for the building addition or site improvements will be coordinated with the appropriate utility providers.

Compatibility and Community Impact:

The proposed improvements are consistent with the existing use of the property and are designed to minimize impacts on neighboring properties. The expanded parking and improved circulation will reduce on-street parking and improve site safety during peak church and school use. Exterior materials for the building addition are designed to match or complement the existing structure, ensuring a cohesive appearance.
Construction activities will be temporary in nature, and appropriate measures will be taken to manage dust, noise, and site access during construction.

TRINITY EVANGELICAL LUTHERAN CHURCH

CITY OF KIEL,
MANITOWOC COUNTY, WI


SHEET INDEX

G - GENERAL SHEETS

- G 1 TITLE SHEET
- G 2 OVERALL LAYOUT SHEET
- G 3 - 7 DETAILS

ST - SITE SHEETS

- ST 1 EXISTING SITE CONDITIONS
- ST 2 EROSION CONTROL AND REMOVAL PLANS
- ST 3 PROPOSED SITE PLAN
- ST 4 GRADING PLAN

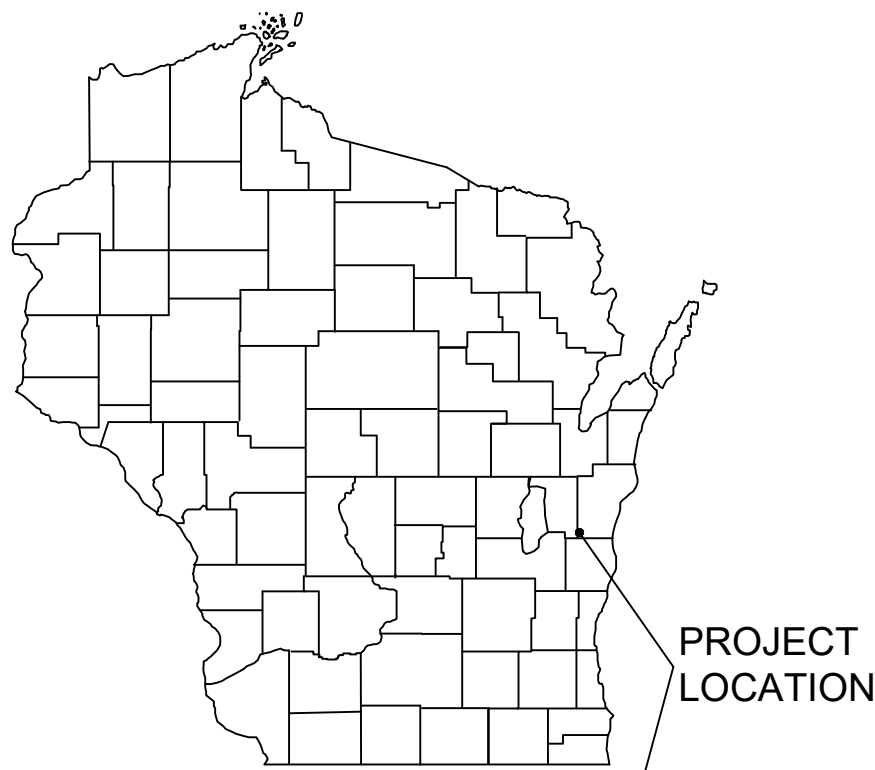

LOCATION MAP
NOT TO SCALE

LEGEND

	EXISTING WATER MAIN
	EXISTING WATER MAIN, VALVE & HYDRANT
	EXISTING WATER SERVICE & CURB STOP
	PROPOSED WATER MAIN, VALVE, & HYDRANT
	PROPOSED WATER SERVICE & CURB STOP
	EXISTING SANITARY SEWER & MANHOLE
	PROPOSED SANITARY SEWER & MANHOLE
	EXISTING FORCEMAIN
	EXISTING STORM SEWER & INLET
	PROPOSED STORM SEWER & INLET
	PROPOSED STORM SEWER & MANHOLE
	BURIED ELECTRIC
	BURIED GAS & VALVE
	BURIED CABLE TELEVISION
	BURIED TELEPHONE
	BURIED FIBER OPTICS
	OVERHEAD UTILITY
	RAILROAD TRACKS
	EXISTING CURB & GUTTER
	PROPOSED CURB & GUTTER
	EXISTING SIDEWALK
	PROPOSED SIDEWALK
	EXISTING CULVERT PIPE
	PROPOSED CULVERT PIPE
	FENCE LINE
	DRAINAGE ARROW
	SILT FENCE
	RIGHT-OF-WAY
	BASELINE
	PROPERTY LINE
	TREE LINE
	BENCHMARK
	IRON PIPE
	IRON ROD
	CONTROL POINT
	UTILITY POLE & GUY
	SOIL BORING
	LIGHT POLE
	PEDESTAL
	STREET SIGN
	MAILBOX
	FLAGPOLE
	TREE - DECIDUOUS
	TREE - CONIFEROUS
	TREE TO BE REMOVED

UTILITIES

- GAS:
- WISCONSIN PUBLIC SERVICE CORP.
GREEN BAY, WI
EMERGENCY: (800) 450-7280
NON EMERGENCY: (800) 450-7260
- ELECTRIC:
- KIEL ELECTRIC UTILITY
621 SIXTH STREET
KIEL, WI 53042
PHONE: (920) 894-2909
- GREAT LAKES UTILITIES
1323 SOUTH 7TH STREET
MANITOWOC, WI 54220
PHONE: (920) 686-4396
- TELEPHONE/CATV:
- SPECTRUM
(833) 267-6094
- SEWER & WATER:
- CITY OF KIEL WATER AND WASTEWATER UTILITY
621 SIXTH STREET
KIEL, WI 53042
PHONE: (920) 894-2909

Dial **811** or (800) 242-8511

www.DiggersHotline.com

NOTE:
UTILITY LOCATIONS SHOWN ON PLANS ARE APPROXIMATE AND CONTRACTOR
SHALL HAVE APPROPRIATE UTILITY MARK EXACT LOCATIONS PRIOR TO
CONSTRUCTION.



PROJECT DATE:	DRAWN BY:	EAE	NO.	DATE	REVISION	BY:
	DESIGNED BY:	AJL	-	-	-	-
	CHECKED BY:	DWR	-	-	-	-
PLOT DATE: 1/22/2026 2:19 PM, G:\22\22701\22701002\CADD\Construction Documents\22701002 General Sheets.dwg						



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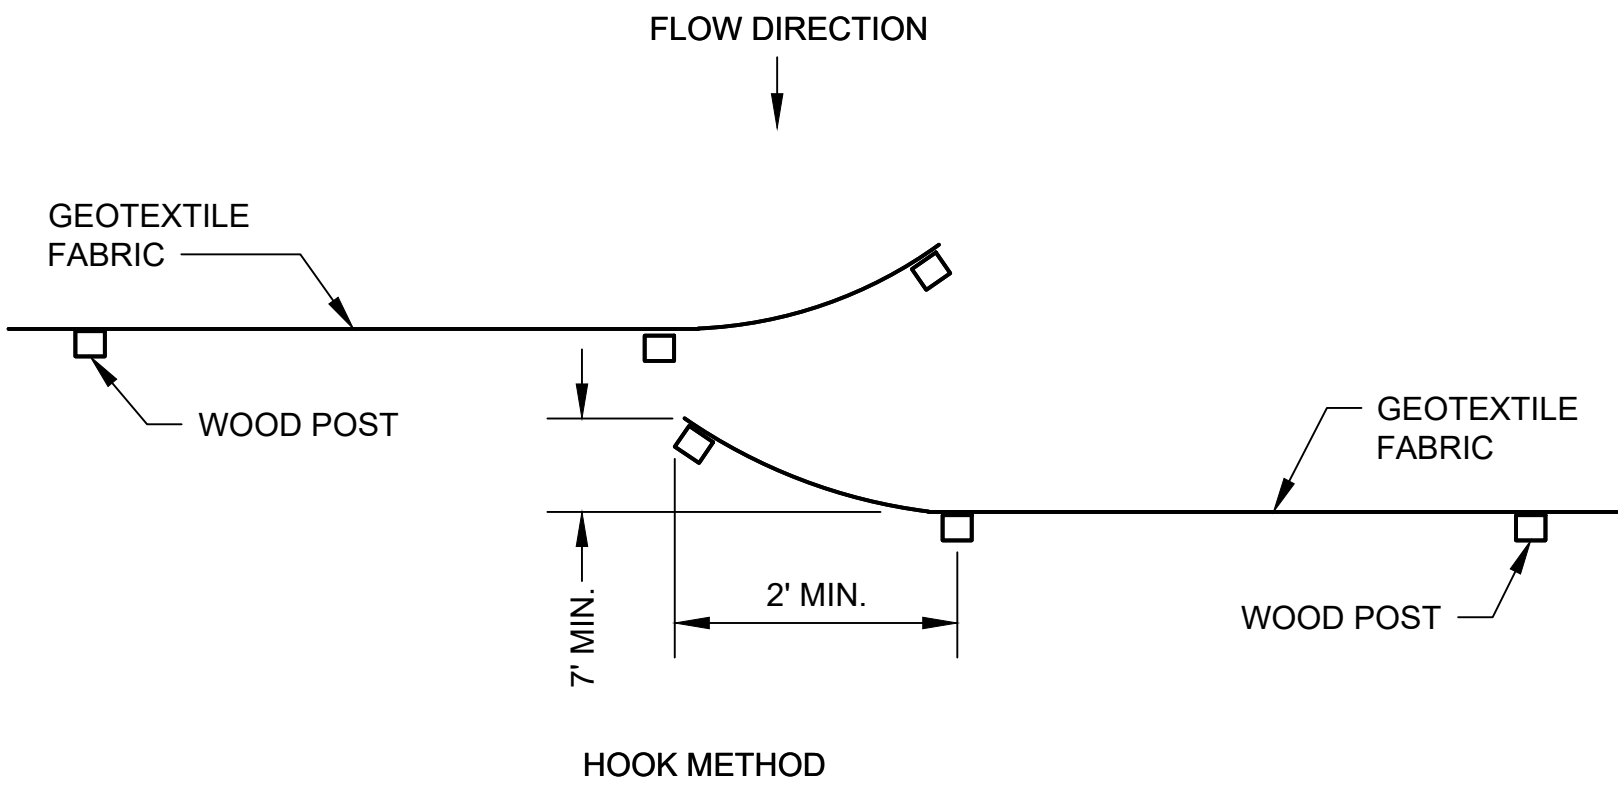
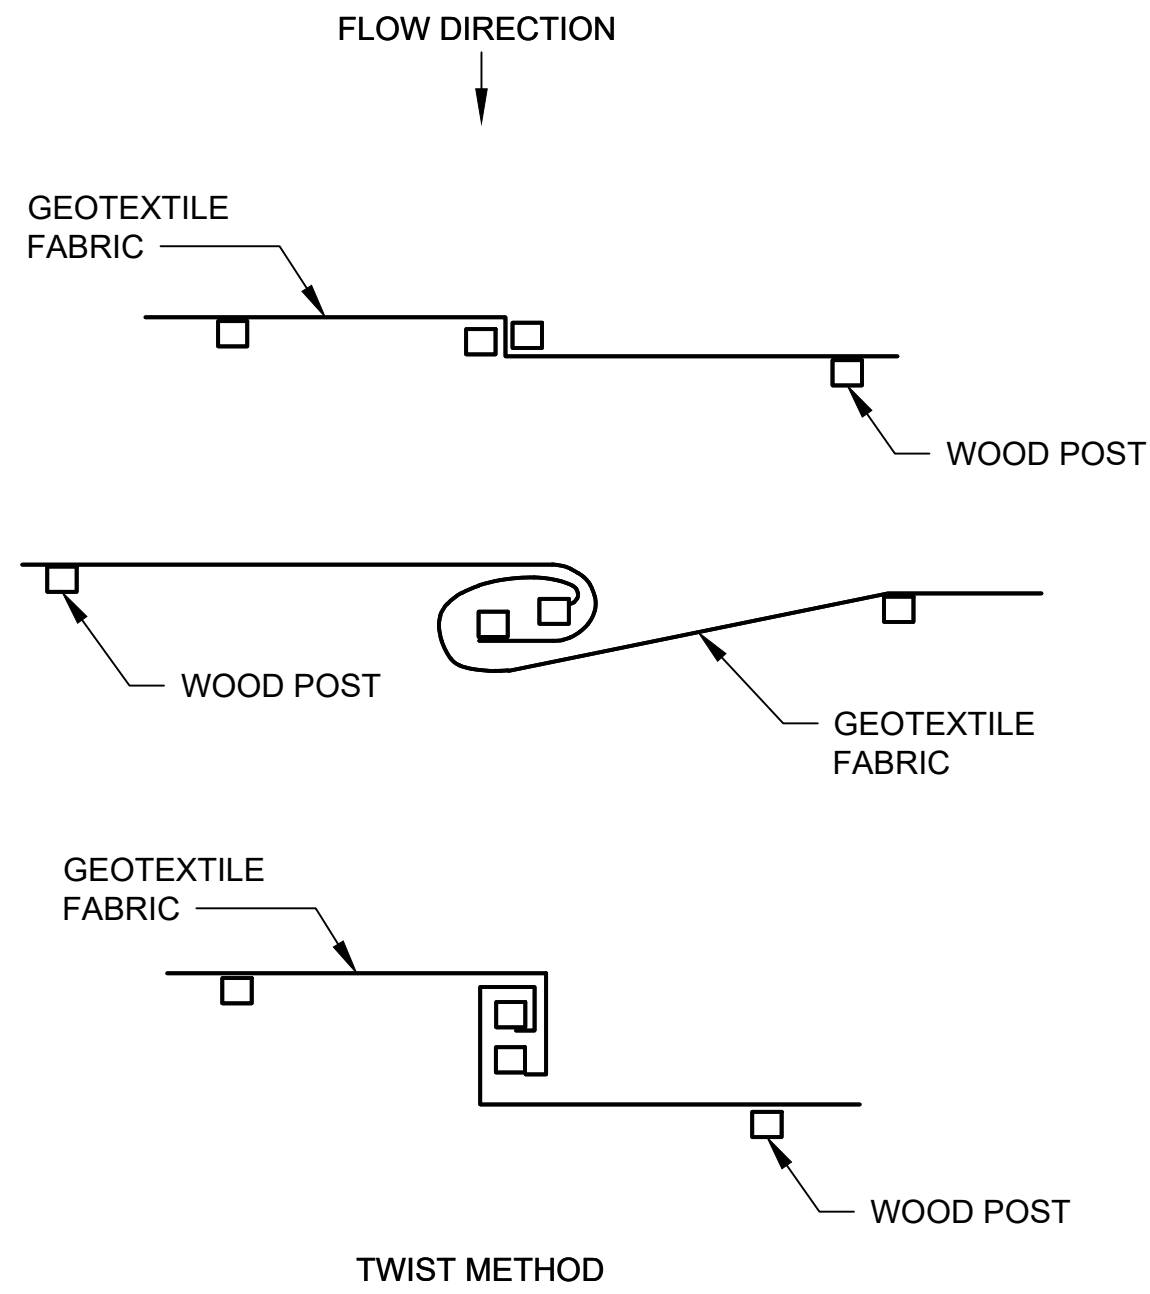
TRINITY EVANGELICAL LUTHERAN CHURCH
CITY OF KIEL
MANITOWOC COUNTY, WISCONSIN

OVERALL LAYOUT SHEET


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CONSTRUCTION SITE
EROSION CONTROL REQUIREMENTS


- SECTION NR216.46 OF WISCONSIN STATE ADMINISTRATIVE CODE IDENTIFIES REQUIREMENTS FOR CONSTRUCTION SITE AND POST-CONSTRUCTION EROSION CONTROL. IT IS THE INTENT OF THESE PLANS TO SATISFY THESE REQUIREMENTS. THE METHODS AND STRUCTURES USED TO CONTROL EROSION SHALL BE THE RESPONSIBILITY OF THE CONTRACTOR. CONTRACTOR SHALL IMPLEMENT AN APPROPRIATE MEANS OF CONTROLLING EROSION DURING SITE OPERATION AND UNTIL THE VEGETATION IS RE-ESTABLISHED. ADJUSTMENTS TO THE CONTROL SYSTEM SHALL BE MADE AS REQUIRED.
- ALL WORK SHALL BE IN ACCORDANCE WITH THE LATEST EDITION OF THE WISCONSIN DNR'S CONSERVATION PRACTICE STANDARDS. THESE STANDARDS ARE PERIODICALLY UPDATED AND IT IS THE CONTRACTOR'S RESPONSIBILITY TO OBTAIN AND REFERENCE THE MOST RECENTLY RELEASED STANDARD.
- THIS INFORMATION IS ONLY ONE PART OF THE OVERALL EROSION CONTROL REQUIREMENTS. ADDITIONAL REQUIREMENTS MAY ALSO BE SHOWN ON THE CONTRACT DRAWINGS AND IN THE ACCOMPANYING SPECIFICATIONS.
- ADDITIONAL EROSION CONTROL MEASURES, AS REQUESTED IN WRITING BY THE STATE OR LOCAL INSPECTORS, OR THE OWNER'S ENGINEER, SHALL BE INSTALLED WITHIN 24 HOURS.
- THE AREA OF EROSION LAND EXPOSED TO THE ELEMENTS BY GRUBBING, EXCAVATION, TRENCHING, BORROW AND FILL OPERATIONS AT ANY ONE TIME SHALL BE MINIMIZED TO THE MAXIMUM EXTENT PRACTICABLE. FOR ANY DISTURBED AREA THAT REMAINS INACTIVE FOR GREATER THAN 7 WORKING DAYS, OR WHERE GRADING WORK EXTENDS BEYOND THE PERMANENT SEEDING DEADLINES, THE SITE MUST BE TREATED WITH TEMPORARY STABILIZATION MEASURES SUCH AS SOIL TREATMENT, TEMPORARY SEEDING AND/OR MULCHING. ALL DISTURBED AREAS SHALL BE TREATED WITH PERMANENT STABILIZATION MEASURES WITHIN 3 WORKING DAYS OF FINAL GRADING.
- ALL EROSION CONTROL MEASURES AND STRUCTURES SERVING THE SITE MUST BE INSPECTED AT LEAST WEEKLY OR WITHIN 24 HOURS OF THE TIME 0.5 INCHES OF RAIN HAS OCCURRED. ALL NECESSARY REPAIR AND MAINTENANCE WILL BE DONE AT THIS INSPECTION TIME.
- ALL EROSION CONTROL DEVICES AND/OR STRUCTURES SHALL BE PROPERLY INSTALLED PRIOR TO CLEARING AND GRUBBING OPERATIONS WITHIN THEIR RESPECTIVE DRAINAGE AREAS. THESE SHALL BE PROPERLY MAINTAINED FOR MAXIMUM EFFECTIVENESS UNTIL VEGETATION IS RE-ESTABLISHED.
- ALL EROSION CONTROL DEVICES SHALL BE PROPERLY INSTALLED PRIOR TO ANY SOIL DISTURBANCE.
- ANY SLOPES STEEPER THAN 3H:1V SHALL BE STAKED WITH EROSION CONTROL FABRIC UNLESS INDICATED ON THE PLAN.
- ALL WASTE AND UNUSED BUILDING MATERIALS (INCLUDING GARBAGE, DEBRIS, CLEANING WASTES, WASTEWATER, TOXIC MATERIALS, OR HAZARDOUS MATERIALS) SHALL BE PROPERLY DISPOSED OF AND NOT ALLOWED TO BE CARRIED OFF-SITE BY RUNOFF OR WIND.
- WIND EROSION SHALL BE KEPT TO A MINIMUM DURING CONSTRUCTION. WATERING, MULCH, OR A TACKING AGENT MAY BE REQUIRED TO PROTECT NEARBY RESIDENCES AND WATER RESOURCES.
- CHANNELIZED RUNOFF ENTERING THE PROJECT SITE FROM ADJOINING LANDS SHALL BE DIVERTED THROUGH NATURALLY OR ARTIFICIALLY EROSION-RESISTANT CONVEYANCES. IF CHANNELIZED RUNOFF CANNOT BE DIVERTED, SITE BEST MANAGEMENT PRACTICES MUST ACCOUNT FOR THE ADDITIONAL FLOW RATES AND EROSION POTENTIAL THAT SUCH RUNOFF PRESENTS.
- THE CONTRACTOR SHALL TAKE ALL POSSIBLE PRECAUTIONS TO PREVENT SOILS FROM BEING TRACKED ONTO PUBLIC OR PRIVATE ROADWAYS. PAVED SURFACES ADJACENT TO CONSTRUCTION SITE VEHICLE ACCESS SHALL BE SWEEP AND/OR SCRAPED (NOT FLUSHED) PERIODICALLY TO REMOVE SOIL, DIRT, AND/OR DUST.
- EROSION CONTROLS SHALL BE INSTALLED ON THE DOWNSTREAM SIDE OF TEMPORARY STOCKPILES. ANY SOIL STOCKPILE THAT REMAINS FOR MORE THAN 7 DAYS SHALL BE COVERED OR TREATED WITH STABILIZATION PRACTICES SUCH AS TEMPORARY OR PERMANENT SEEDING AND MULCHING. ALL STOCK PILES SHALL BE PLACED AT LEAST 75 FEET FROM STREAMS OR WETLANDS.
- ADDITIONAL EROSION CONTROL FOR UTILITY CONSTRUCTION (STORM SEWER, SANITARY SEWER, WATER MAIN, ETC.) SHALL INCLUDE THE FOLLOWING:
 - PLACE EXCAVATED TRENCH MATERIAL ON THE HIGH SIDE OF THE TRENCH.
 - BACKFILL, COMPACT, AND STABILIZE THE TRENCH IMMEDIATELY AFTER PIPE CONSTRUCTION.
 - DISCHARGE OF TRENCH WATER OR DEWATERING EFFLUENT MUST BE PROPERLY TREATED TO REMOVE SEDIMENT IN ACCORDANCE WITH THE WDNR CONSERVATION PRACTICE STANDARD 1061 - DEWATERING OR A SUBSEQUENT WDNR DEWATERING STANDARD PRIOR TO DISCHARGE INTO A STORM SEWER, DITCH, DRAINAGEWAY, OR WETLAND OR LAKE.
- ALL DRAINAGE CULVERTS, STORM DRAIN INLETS, MANHOLES, OR ANY OTHER EXISTING STRUCTURES THAT COULD BE DAMAGED BY SEDIMENTATION SHALL BE PROTECTED ACCORDING TO THE VARIOUS METHODS PROVIDED IN THE PRINTED CONSERVATION PRACTICE STANDARDS.
- ANY SOIL EROSION THAT OCCURS AFTER FINAL GRADING AND/OR STABILIZATION MUST BE REPAIRED AND THE STABILIZATION WORK REDONE.
- THE FIRST SIX WEEKS AFTER INITIAL STABILIZATION, ALL NEWLY SEEDED AND MULCHED AREAS SHALL WATERED WHENEVER 7 DAYS ELAPSE WITHOUT A RAIN EVENT.
- WHEN THE DISTURBED AREA HAS BEEN STABILIZED BY PERMANENT VEGETATION OR OTHER MEANS, TEMPORARY BMP'S SUCH AS SILT FENCES, STRAW BALES, AND SEDIMENT TRAPS SHALL BE REMOVED AND THESE AREAS STABILIZED.
- ALL TEMPORARY BEST MANAGEMENT PRACTICES SHALL BE MAINTAINED UNTIL THE SITE IS STABILIZED.
- ALL DISTURBED AREAS SHALL BE PERMANENTLY STABILIZED WITH SEED AND MULCH UNLESS OTHERWISE SPECIFIED. A MINIMUM OF FOUR INCHES OF TOPSOIL SHALL BE APPLIED TO ALL AREAS TO BE SEEDED OR SODDED.



JOINING TWO LENGTHS OF SILT FENCE ③

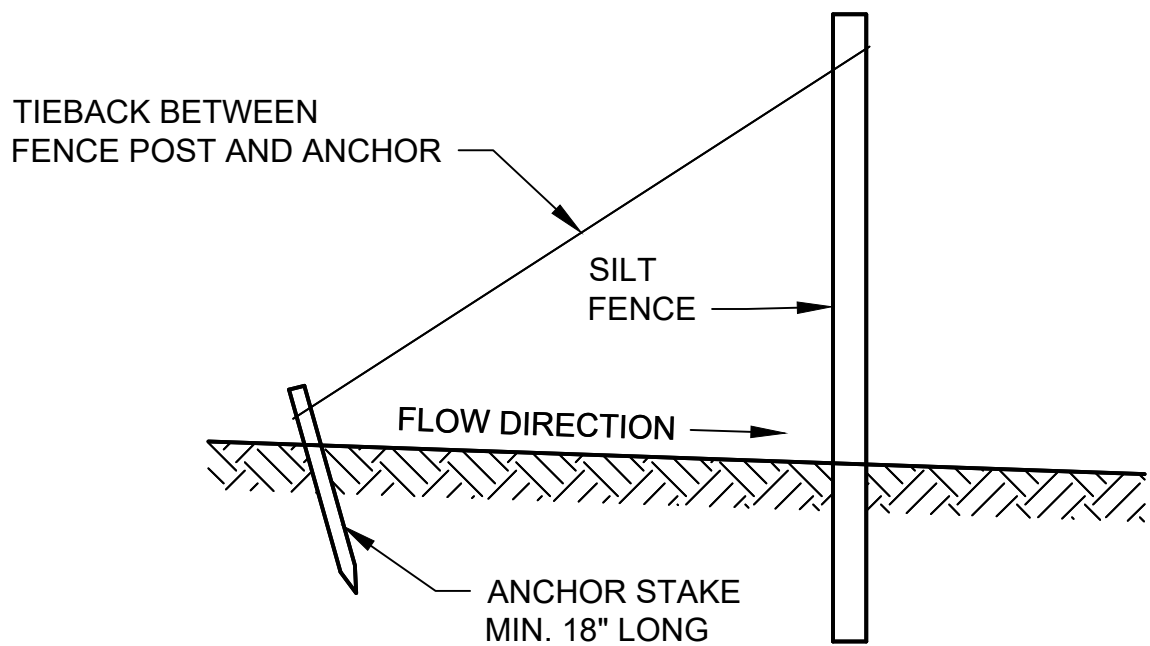

SILT FENCE TIE BACK
(WHEN REQUIRED BY THE ENGINEER)

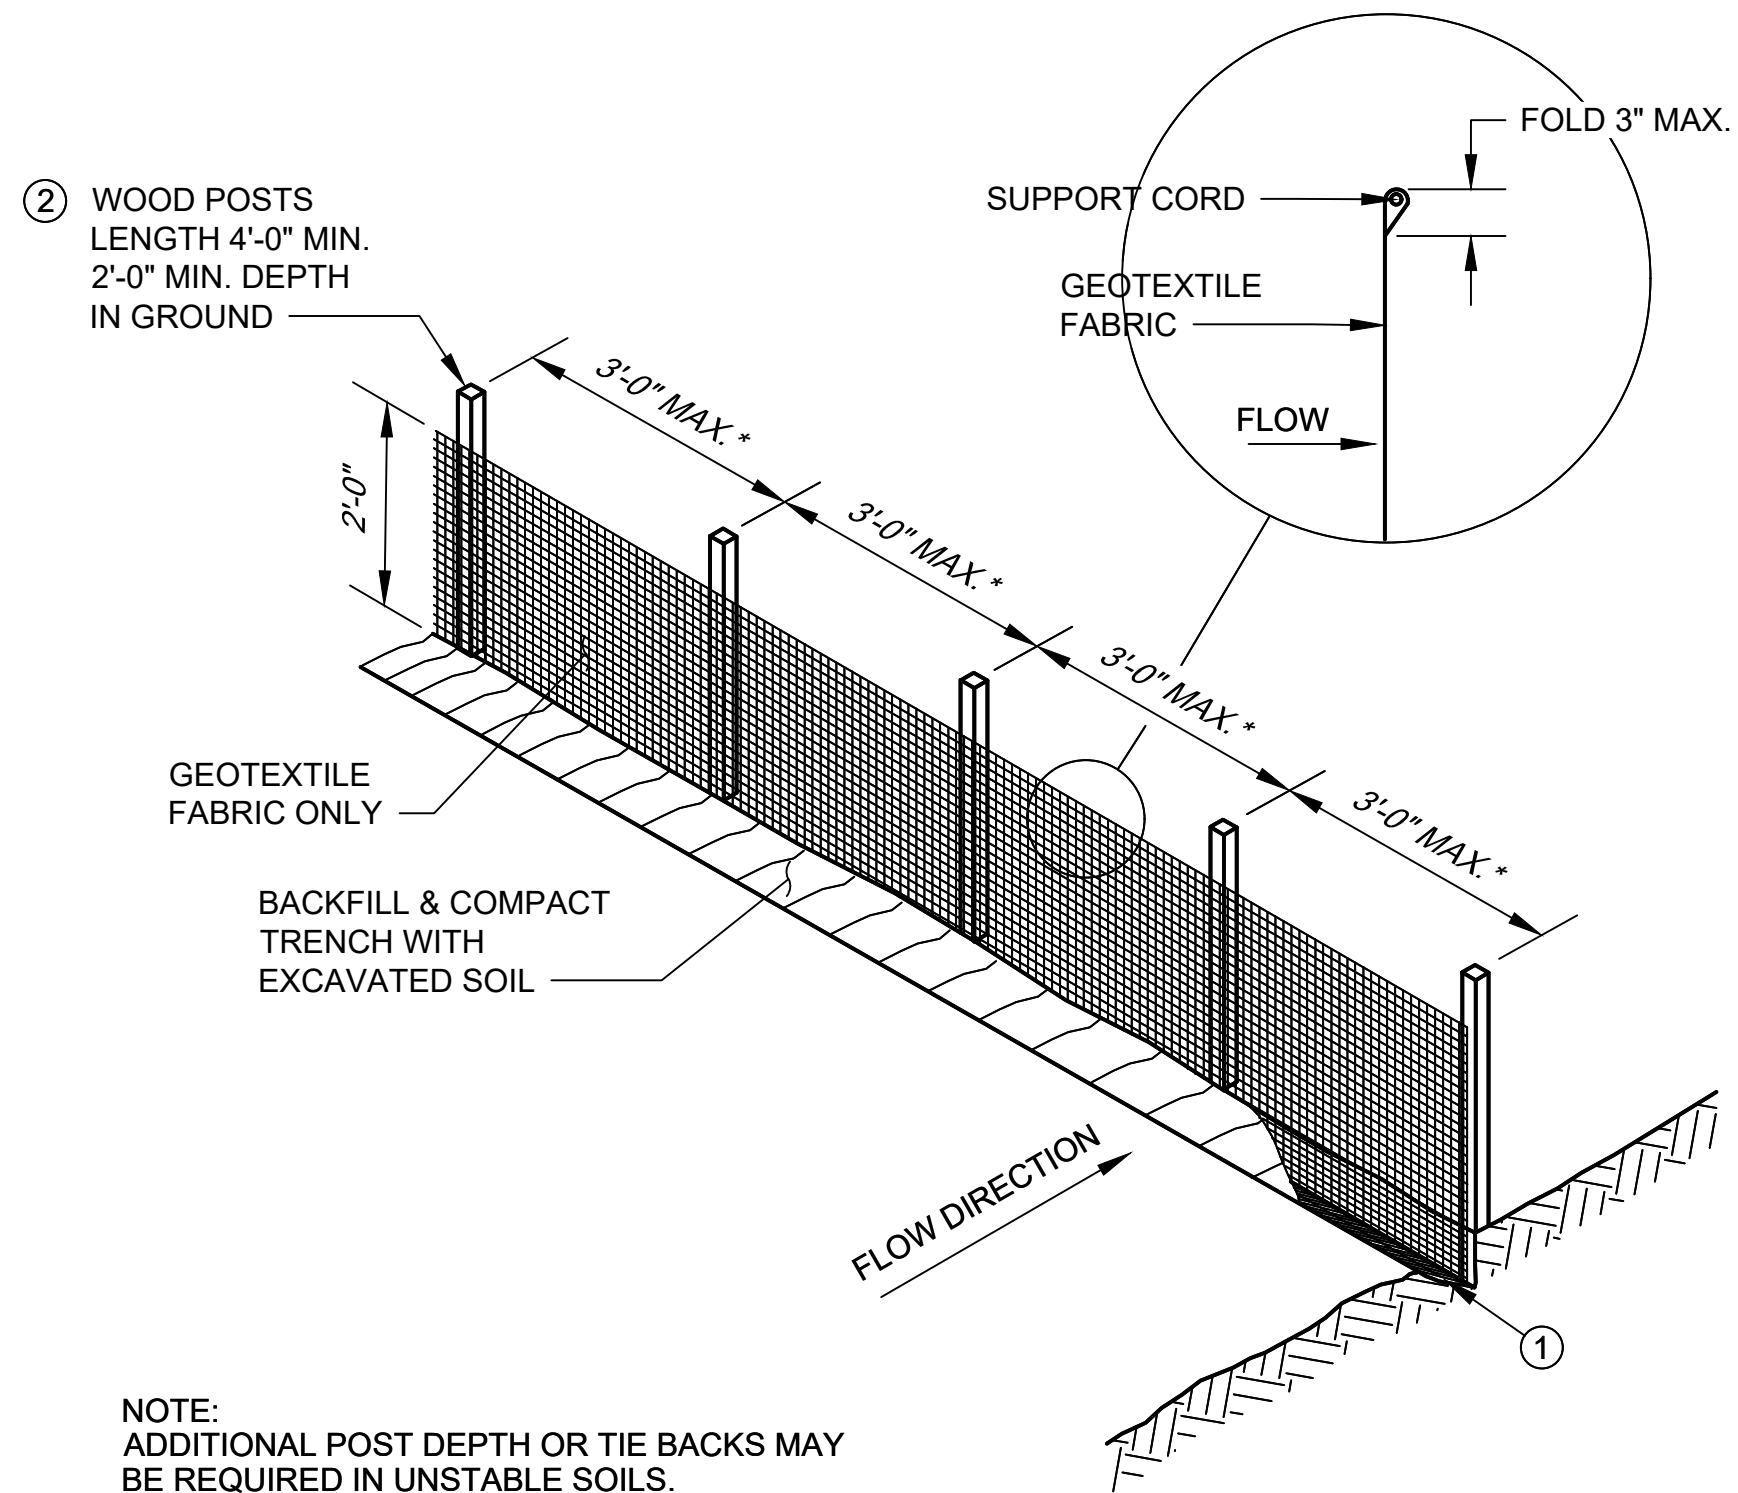

NOTE:
ADDITIONAL POST DEPTH OR TIE BACKS MAY
BE REQUIRED IN UNSTABLE SOILS.


* 8'-0" POST SPACING ALLOWED IF A WOVEN
GEOTEXTILE FABRIC IS USED, OR IF THE SILT
FENCE IS FACTORY ASSEMBLED.

ATTACH THE FABRIC TO THE POSTS WITH
WIRE STAPLES OR WOODEN LATH AND NAILS.

SILT FENCE

GENERAL NOTES

- TRENCH SHALL BE A MINIMUM OF 4" WIDE & 6" DEEP TO BURY AND ANCHOR THE GEOTEXTILE FABRIC. FOLD MATERIAL TO FIT TRENCH AND BACKFILL & COMPACT TRENCH WITH EXCAVATED SOIL.
- WOOD POSTS SHALL BE A MINIMUM SIZE OF 1 1/8" x 1 1/8" OF OAK OR HICKORY.
- CONSTRUCT SILT FENCE FROM A CONTINUOUS ROLL IF POSSIBLE BY CUTTING LENGTHS TO AVOID JOINTS. IF A JOINT IS NECESSARY USE ONE OF THE FOLLOWING TWO METHODS: A) TWIST METHOD -- OVERLAP THE END POSTS AND TWIST, OR ROTATE, AT LEAST 180 DEGREES, B) HOOK METHOD -- HOOK THE END OF EACH SILT FENCE LENGTH.

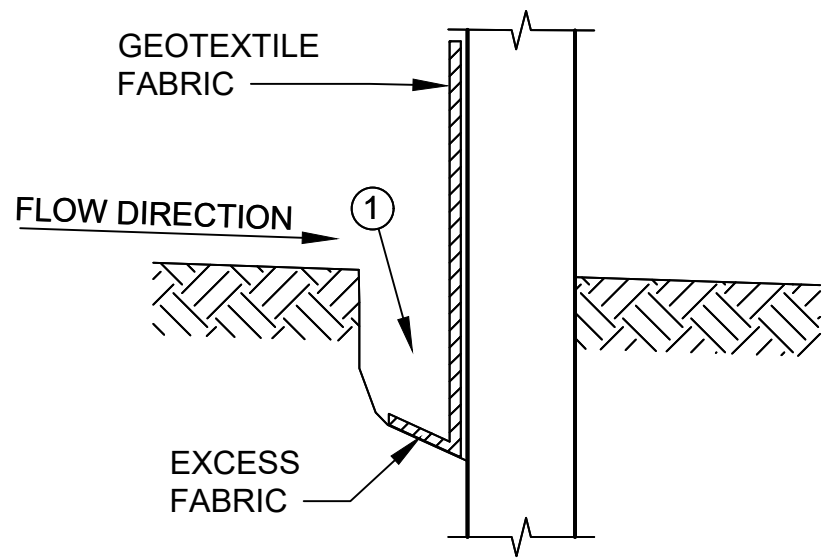

TRENCH DETAIL

PROJECT DATE:	DRAWN BY:	EAE	NO.	DATE	REVISION	BY:
	DESIGNED BY:	AJL				
	CHECKED BY:	DWR				

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22701002
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		NO.	DATE	REVISION	BY
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	DESIGNED BY: AJL	-	-	-	-
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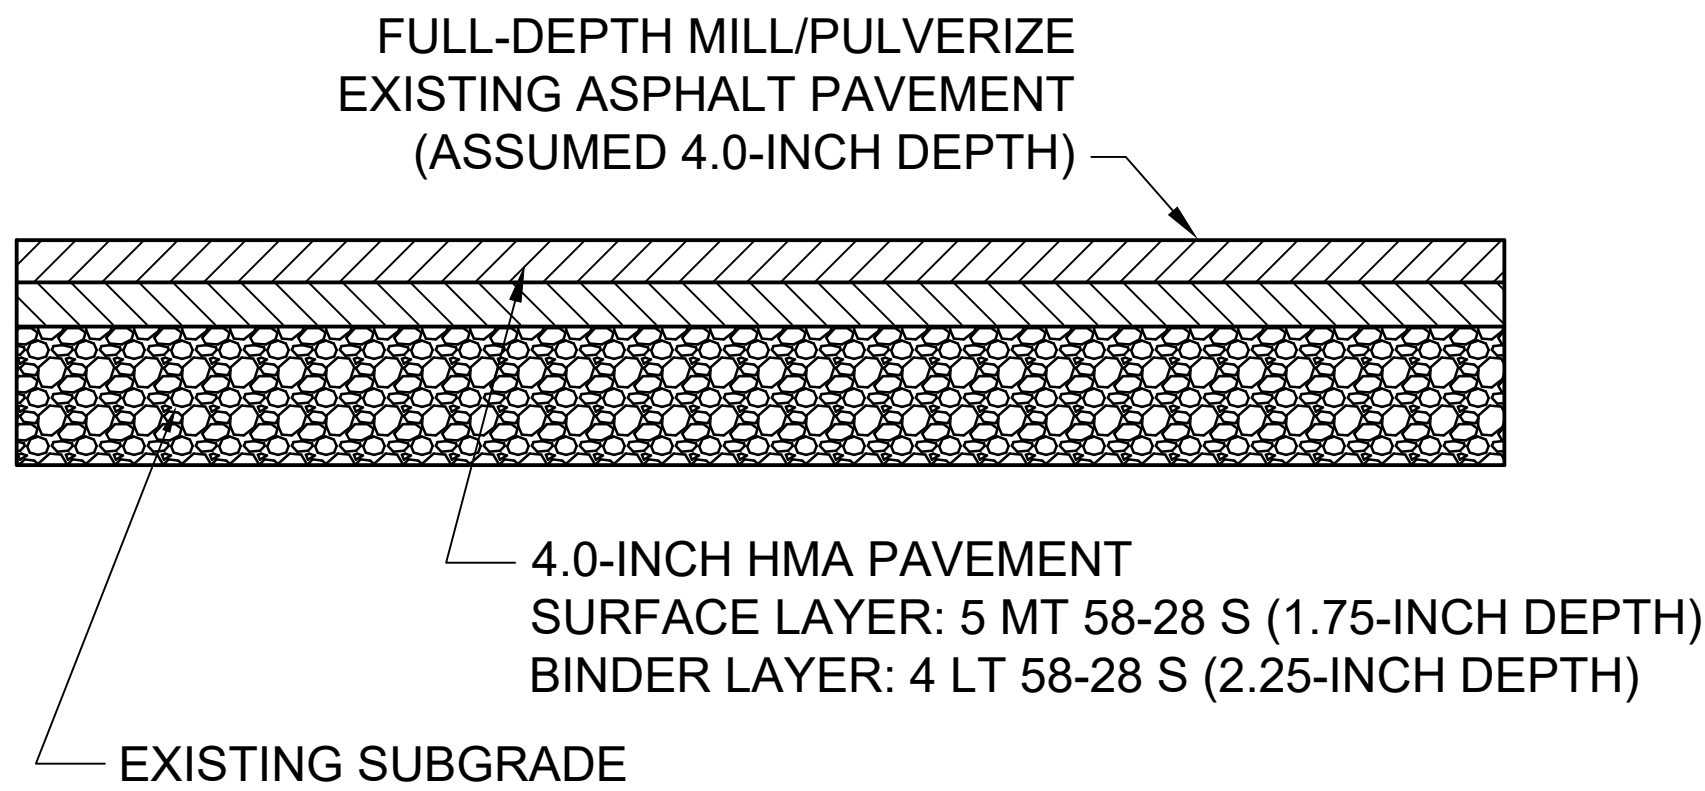


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CITY OF KIEL
MANITOWOC COUNTY, WISCONSIN


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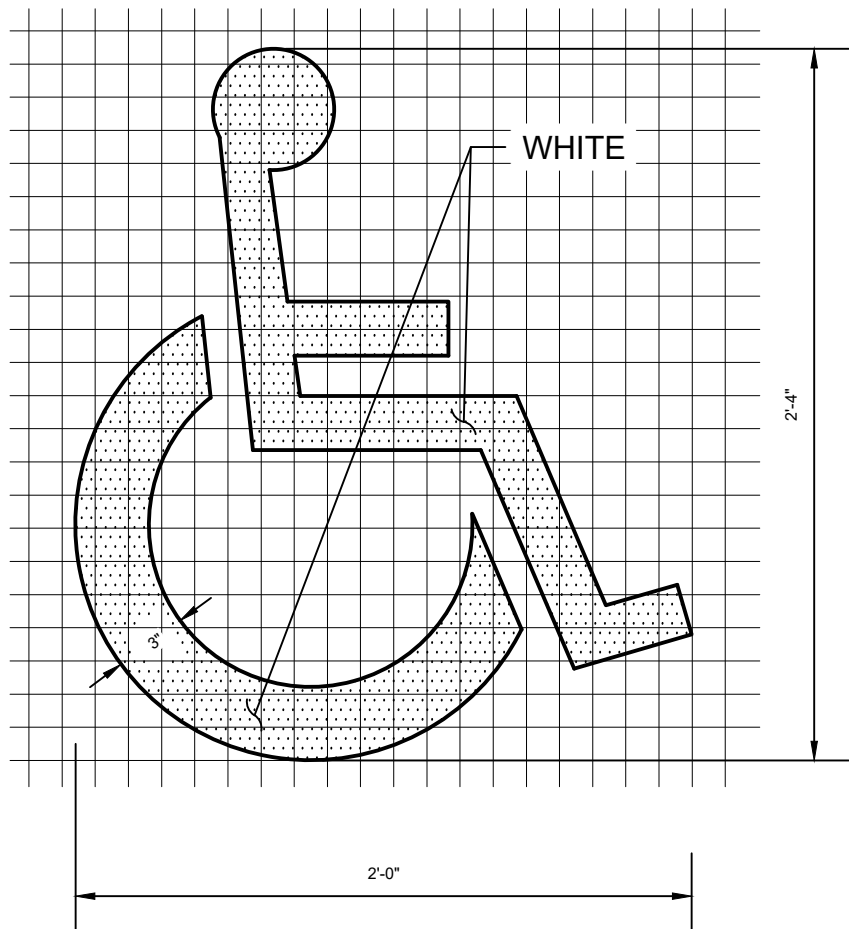
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ASPHALT PAVEMENT SECTION - MILLING
NO SCALE




ASPHALT PAVEMENT SECTION
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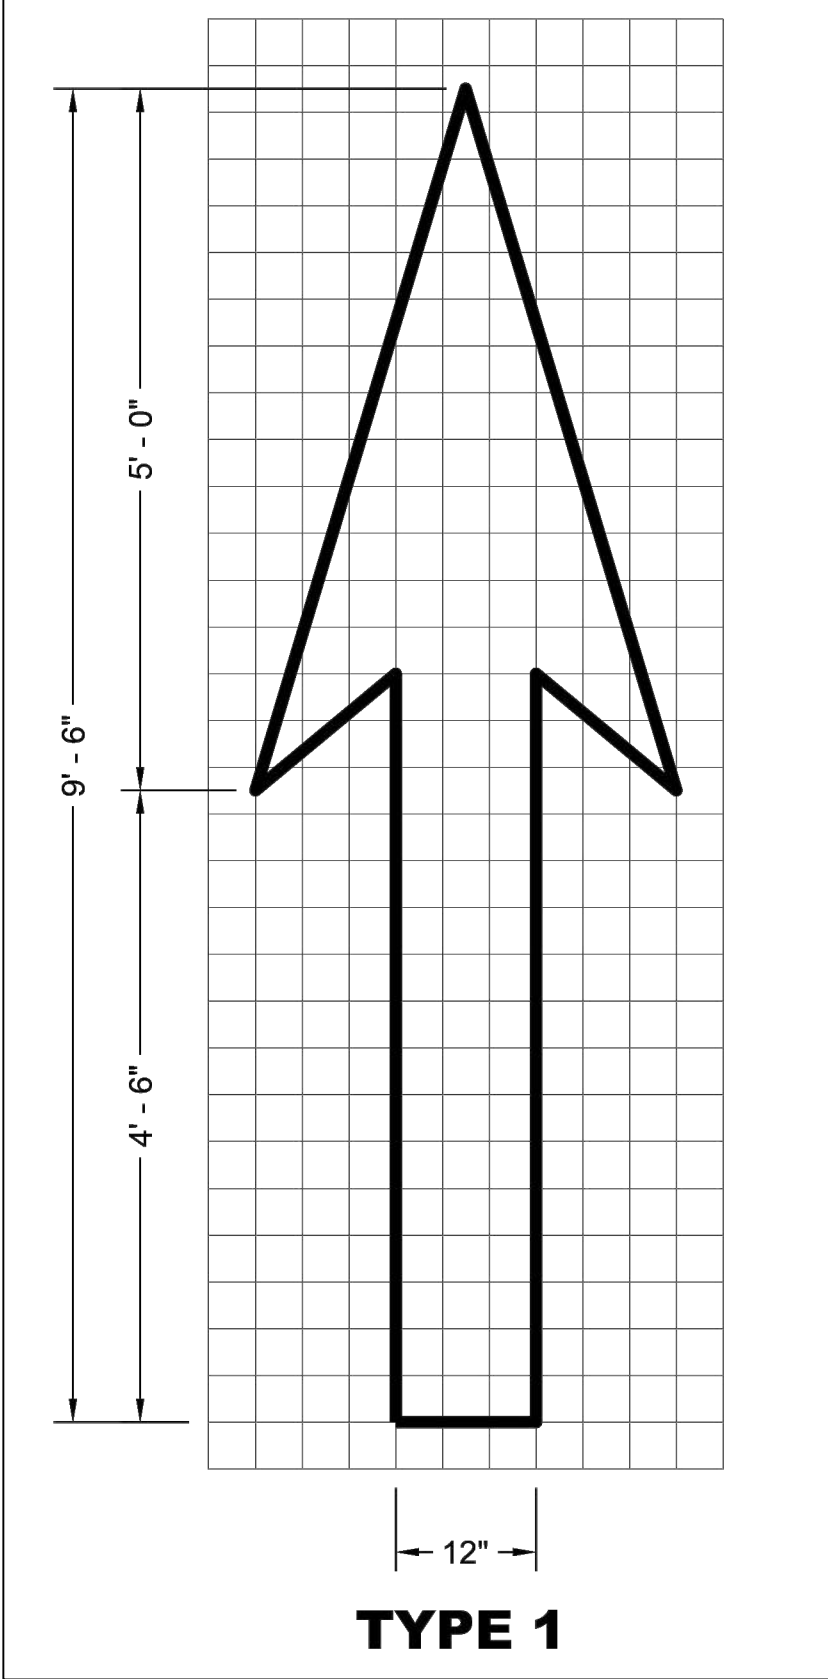


INTERNATIONAL SYMBOL OF ACCESS
NO SCALE


- GENERAL NOTES:
1. DETAILS OF INSTALLATION, MATERIALS AND WORKMANSHIP NOT SHOWN ON THIS DRAWING SHALL CONFORM TO THE PERTINENT REQUIREMENTS OF THE SPECIFICATIONS.
 2. A DETAILED DRAWING OF THE DISABLED PARKING SYMBOL IS ILLUSTRATED IN THE "STANDARD HIGHWAY SIGNS MANUAL" BY THE FEDERAL HIGHWAY ADMINISTRATION.
 3. WDOT SPEC. MEANS THE STATE OF WISCONSIN STANDARD SPECIFICATION FOR HIGHWAY AND STRUCTURE CONSTRUCTION, LATEST EDITION, AS AMENDED BY THE MOST CURRENT INTERIM SUPPLEMENTAL SPECIFICATION.
 4. PROVIDE DISABLED PARKING STALLS AT LOCATIONS SHOWN ON THE DRAWINGS. STALL AND ACCESS ISLE DIMENSIONS SHALL BE AS SHOWN ON THE DETAIL UNLESS INDICATED OTHERWISE ON THE DRAWING.
 5. PROVIDE A DISABLED SYMBOL AND BARRIER FREE SIGNAGE FOR EACH STALL SHOWN ON THE DRAWING.
 6. PROVIDE WHEEL STOPS WHEN SHOWN ON THE DRAWINGS.
 7. THE MAXIMUM SURFACE SLOPE, ACROSS STALLS OR ACCESSIBLE ROUTES, IN ANY DIRECTION, SHALL BE 2%.

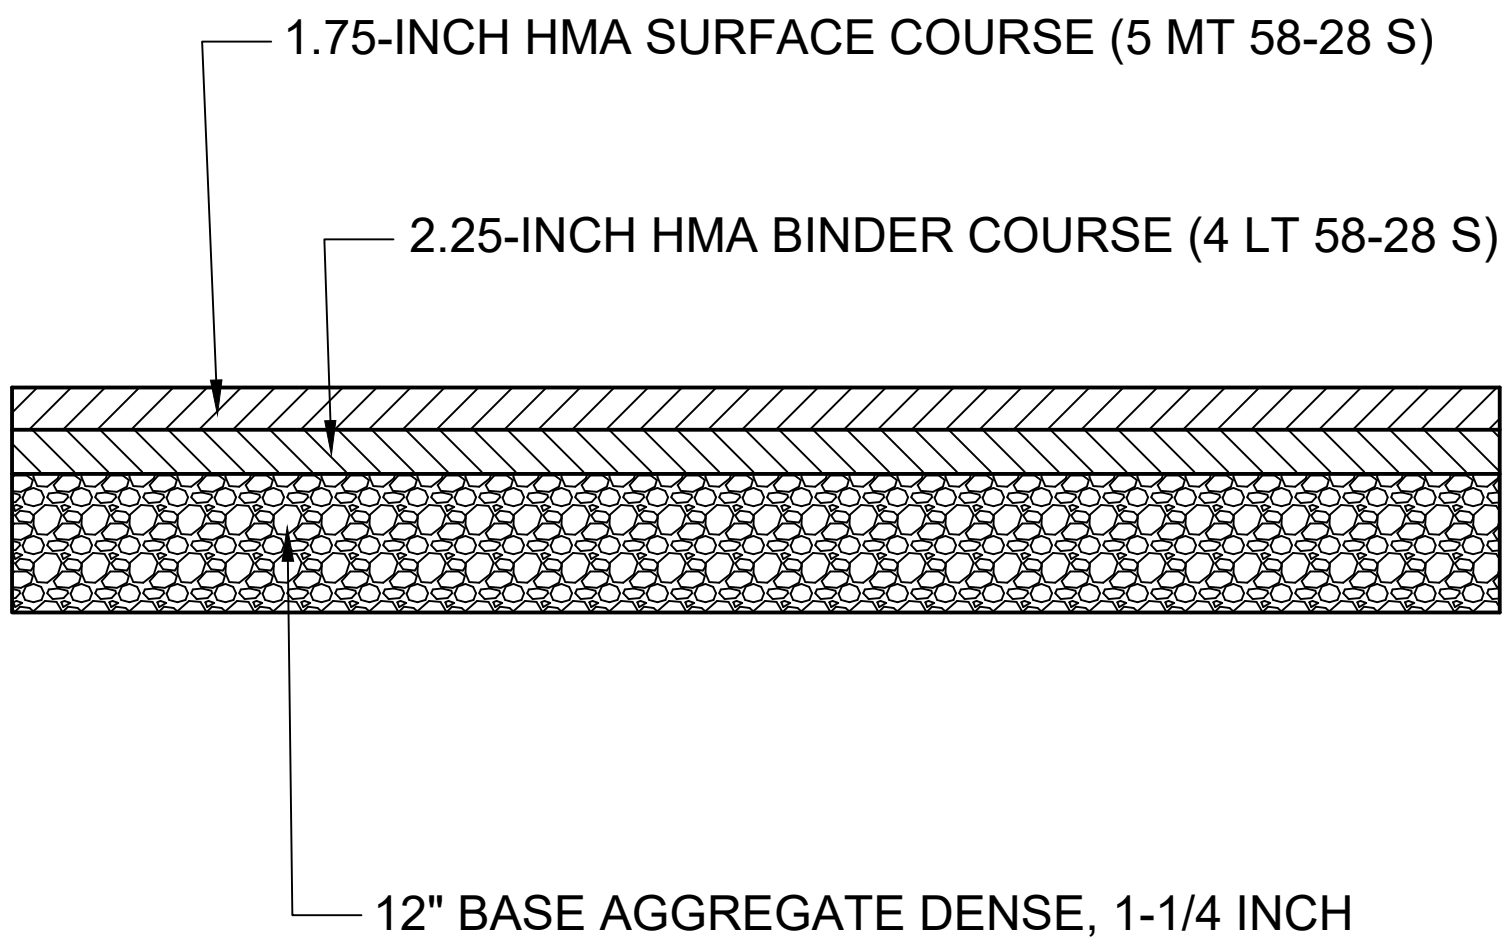

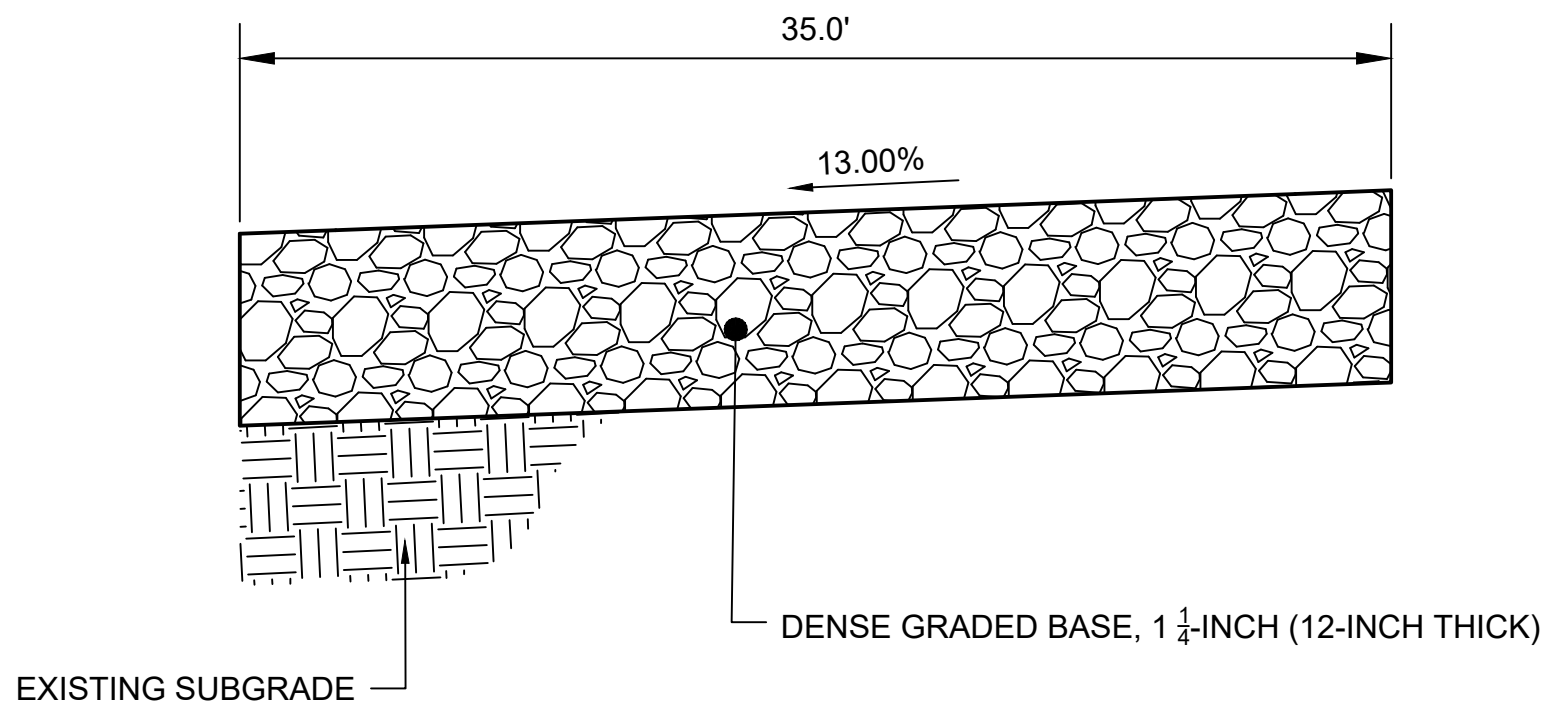FIELD ENTRANCE TYPICAL SECTION
NOT TO SCALE



PAVEMENT MARKING ARROW
NO SCALE

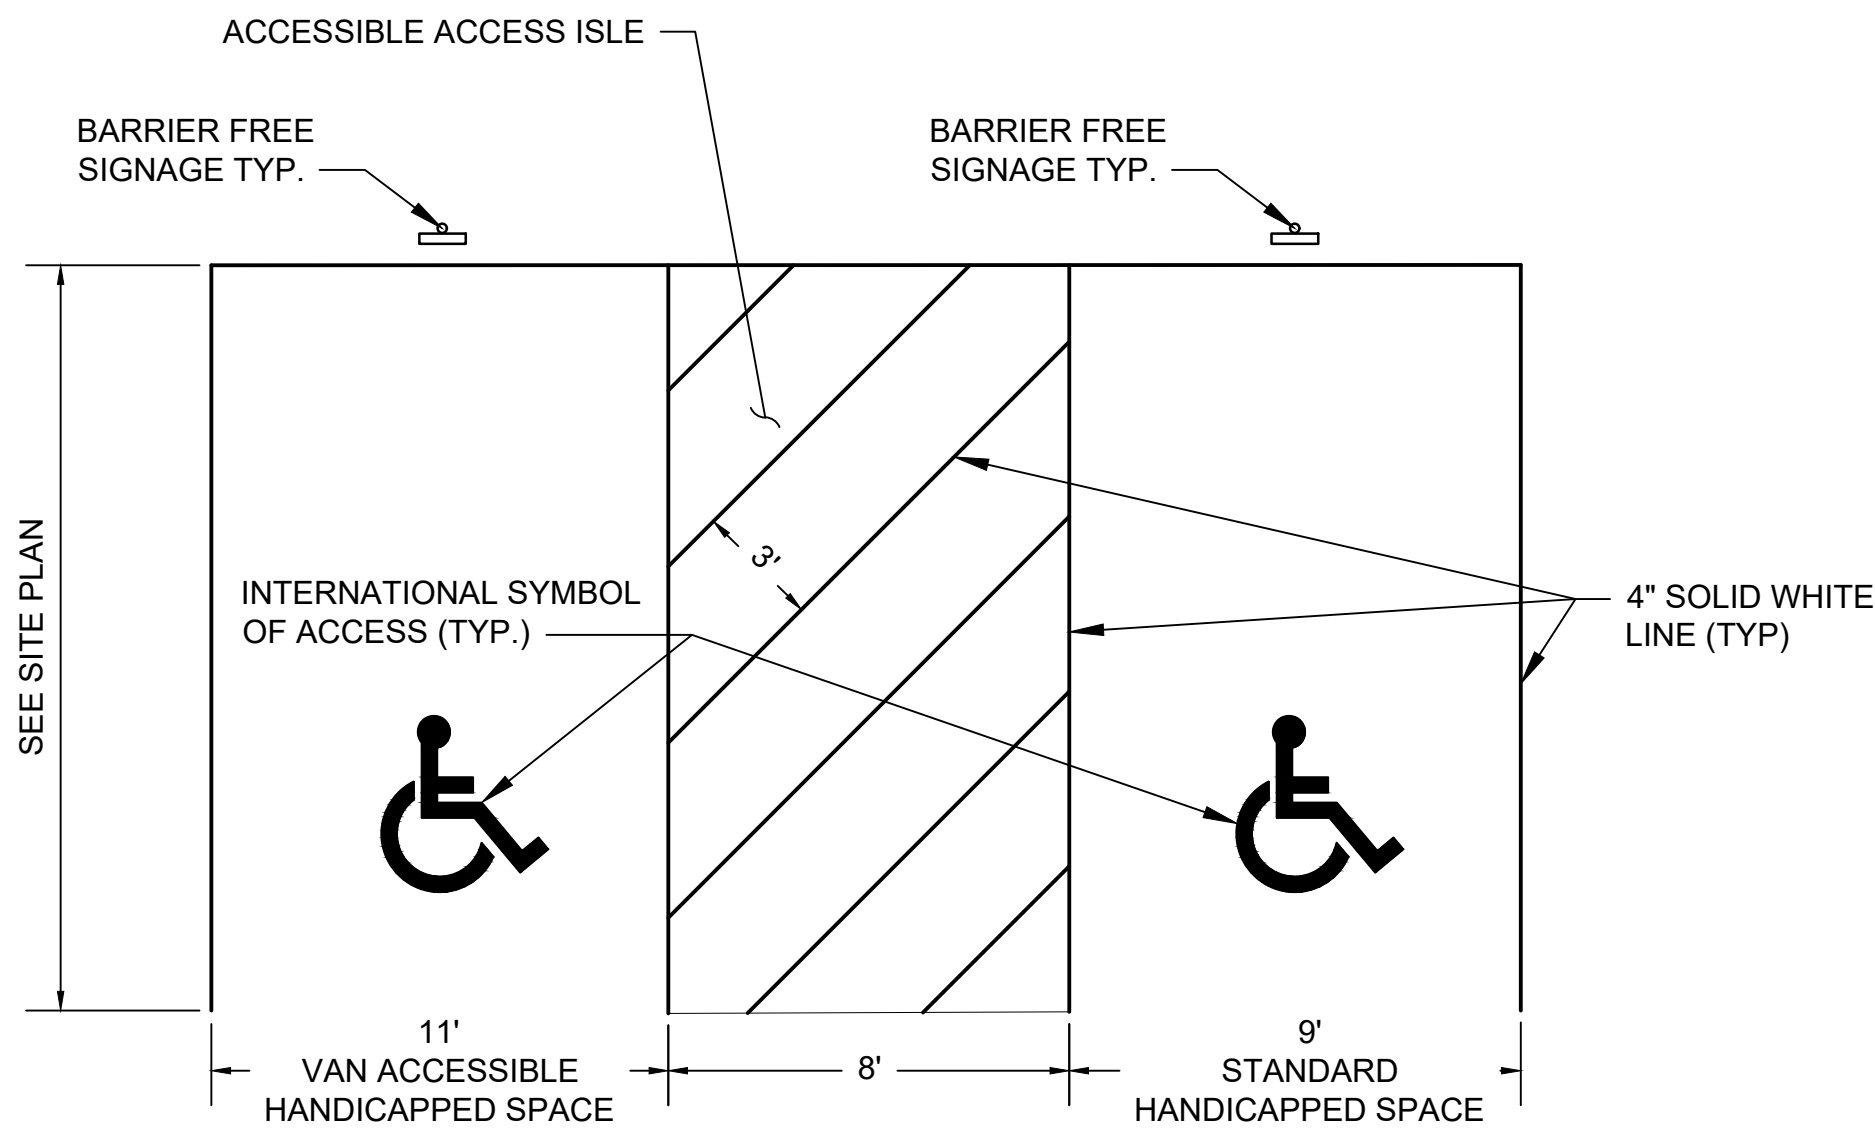

ACCESSIBLE PARKING STALL
NO SCALE

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	DESIGNED BY:	AJL	-	-	-	-
	CHECKED BY:	DWR	-	-	-	-

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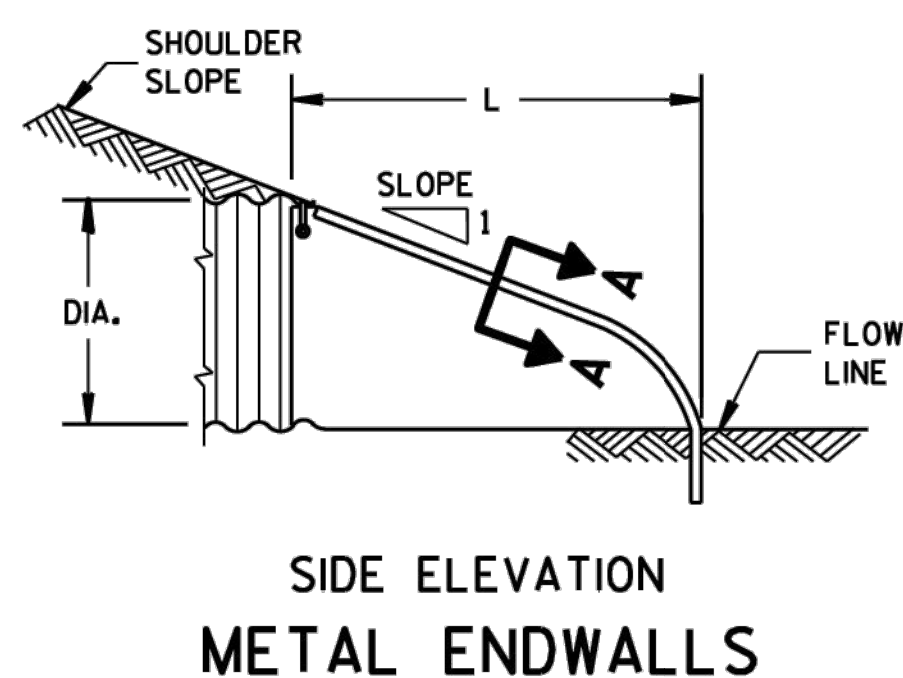
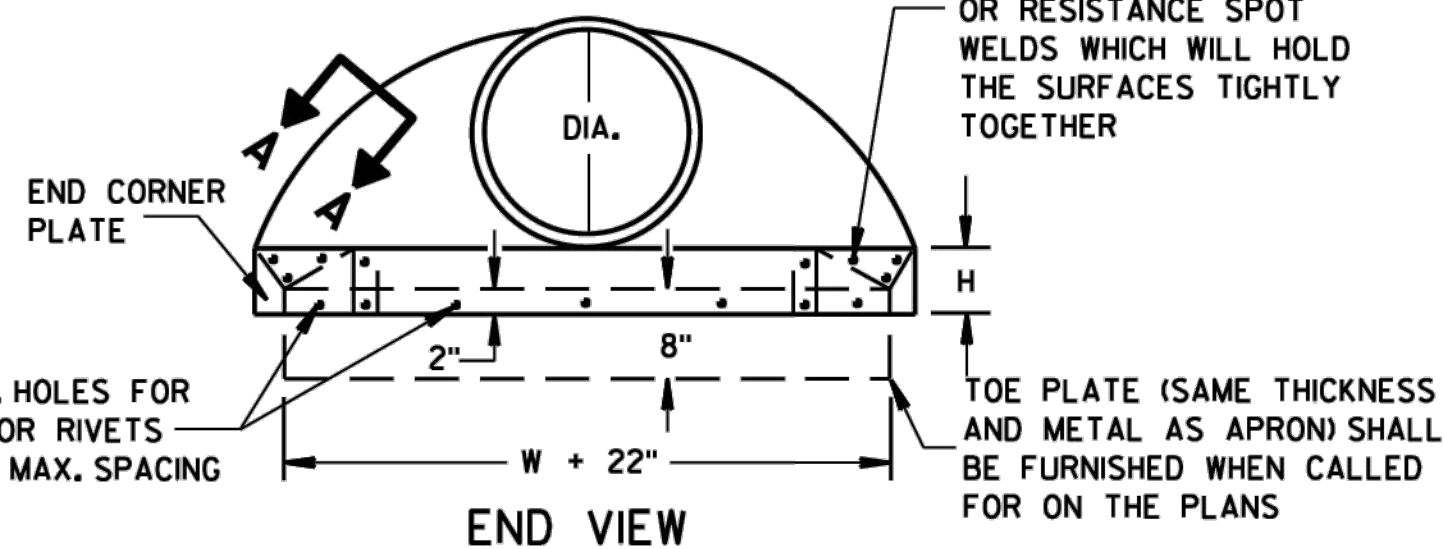
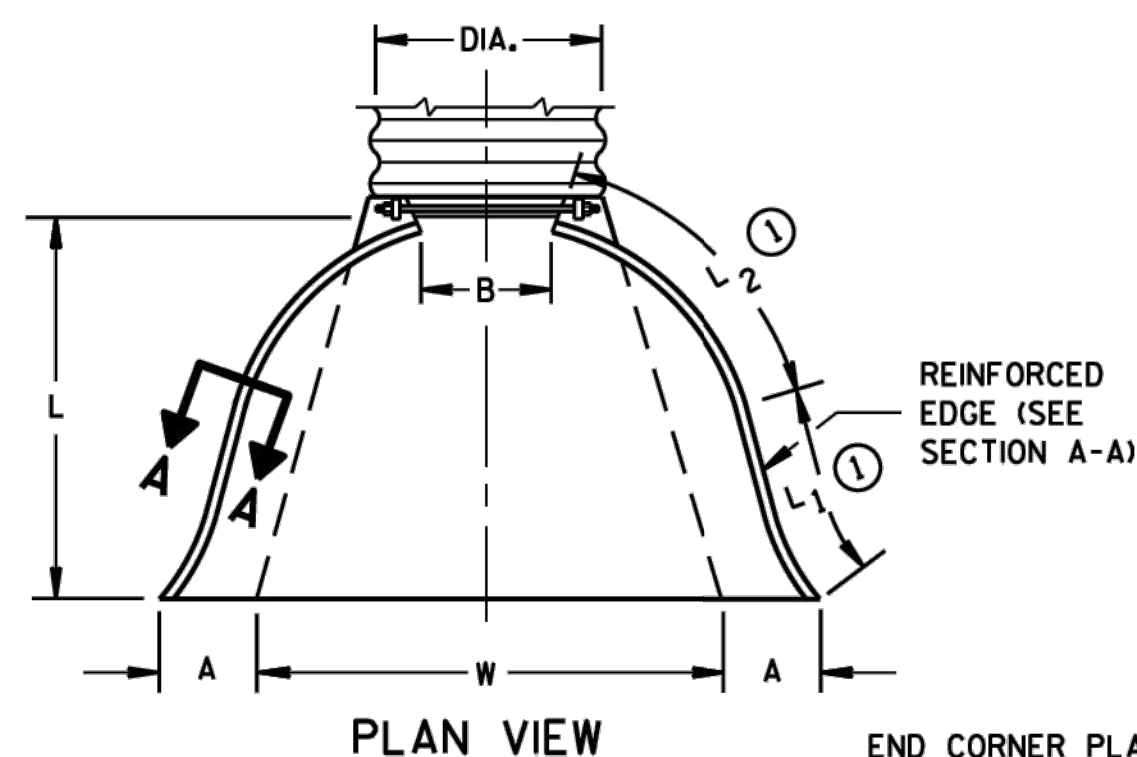
CONSTRUCTION DETAILS

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SDD 8F1 Apron Endwalls for Culvert Pipe




METAL APRON ENDWALLS										
PIPE DIA. (IN.)	MIN. THICK. (Inches)		DIMENSIONS (Inches)							APPROX. SLOPE
	STEEL	ALUM.	A (±1")	B (MAX.)	H (±1")	L (±1 1/2")	L ₁ ①	L ₂ ①	W (±2")	
12	.064	.060	6	6	6	21	12	17 1/2	24	2 1/2 to 1
15	.064	.060	7	8	6	26	14	21 3/4	30	2 1/2 to 1
18	.064	.060	8	10	6	31	15	28 1/4	36	2 1/2 to 1
21	.064	.060	9	12	6	36	18	29 3/8	42	2 1/2 to 1
24	.064	.075	10	13	6	41	18	37 1/4	48	2 1/2 to 1
30	.079	.075	12	16	8	51	18	52 1/4	60	2 1/2 to 1
36	.079	.105	14	19	9	60	24	59 3/4	72	2 1/2 to 1
42	.109	.105	16	22	11	69	24	75 5/8	84	2 1/2 to 1
48	.109	.105	18	27	12	78	24	81	90	2 1/4 to 1
54	.109	.105	18	30	12	84	30	85 1/2	102	2 1/4 to 1
60	.109x	.105x	18	33	12	87	—	—	114	2 to 1
66	.109x	.105x	18	36	12	87	—	—	120	2 to 1
72	.109x	.105x	18	39	12	87	—	—	126	2 to 1
78	.109x	.105x	18	42	12	87	—	—	132	1 1/2 to 1
84	.109x	.105x	18	45	12	87	—	—	138	1 1/2 to 1
90	.109x	.105x	18	37	12	87	—	—	144	1 1/2 to 1
96	.109x	.105x	18	35	12	87	—	—	150	1 1/2 to 1

* EXCEPT CENTER PANEL
SEE GENERAL NOTES




REINFORCED CONCRETE APRON ENDWALLS								
PIPE DIA. (IN.)	DIMENSIONS (Inches)							APPROX. SLOPE
	T	A	B	C	D	E	G	
12	2	4	24	48 ¹ / ₈	72 ¹ / ₈	24	2	3 to 1
15	2 ¹ / ₄	6	27	46	73	30	2 ¹ / ₄	3 to 1
18	2 ¹ / ₂	9	27	46	73	36	2 ¹ / ₂	3 to 1
21	2 ³ / ₄	9	36	37 ¹ / ₂	73 ¹ / ₂	42	2 ³ / ₄	3 to 1
24	3	9 ¹ / ₂	43 ¹ / ₂	30	73 ¹ / ₂	48	3	3 to 1
27	3 ¹ / ₄	10 ¹ / ₂	49 ¹ / ₂	24	73 ¹ / ₂	54	3 ¹ / ₄	3 to 1
30	3 ¹ / ₂	12	54	19 ³ / ₄	73 ¹ / ₂	60	3 ¹ / ₂	3 to 1
36	4	15	63	34 ³ / ₄	97 ³ / ₄	72	4	3 to 1
42	4 ¹ / ₂	21	63	35	98	78	4 ¹ / ₂	3 to 1
48	5	24	72	26	98	84	5	3 to 1
54	5 ¹ / ₂	27	65	33 ¹ / ₄ -35	98 ¹ / ₄ -100	90	5 ¹ / ₂	2 ¹ / ₂ to 1
60	6	30-35	60	39	99	96	5	2 to 1
66	6 ¹ / ₂	30-35	72-78	21-27	99	102	5 ¹ / ₂	2 to 1
72	7	30-35	78	21	99	108	6	2 to 1
78	7 ¹ / ₂	30-35	78	21	99	114	6 ¹ / ₂	2 to 1
84	8	36	90 ¹ / ₂	21	111 ¹ / ₂	120	6 ¹ / ₂	1 ¹ / ₂ to 1
90	8 ¹ / ₂	41	87 ¹ / ₂	24	111 ¹ / ₂	132	6 ¹ / ₂	1 ¹ / ₂ to 1





* MINIMUM
** MAXIMUM

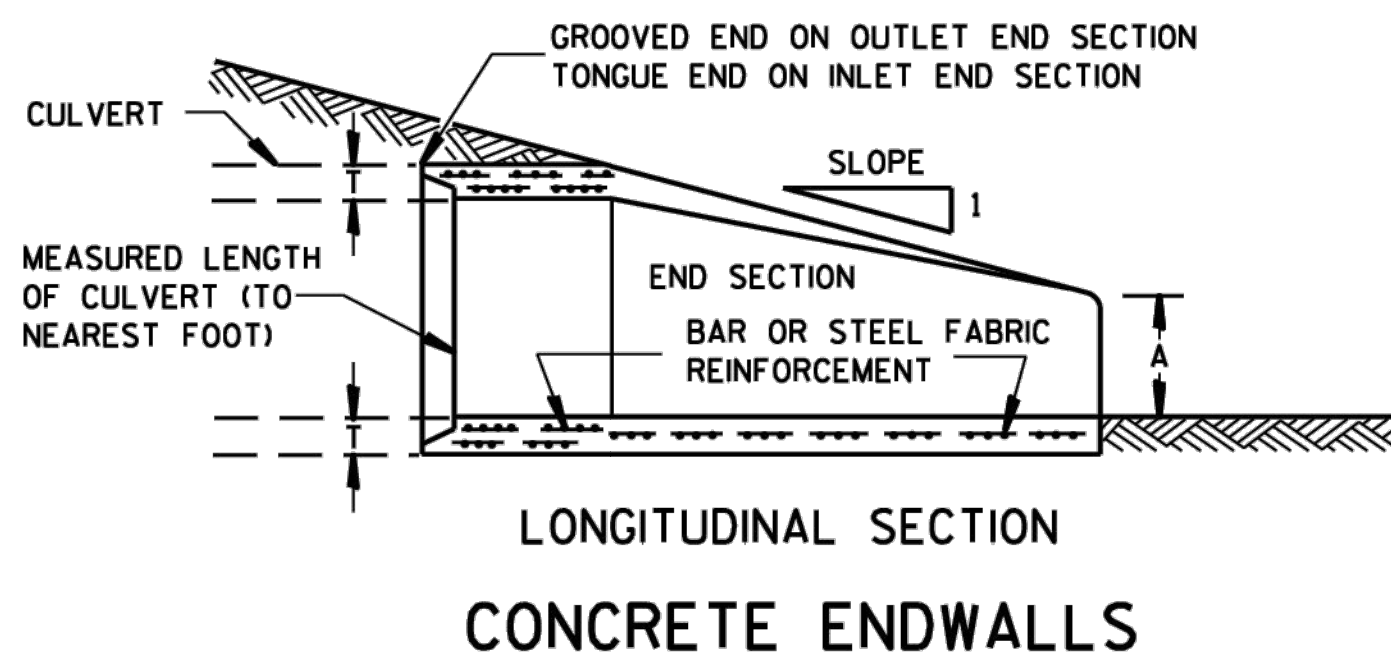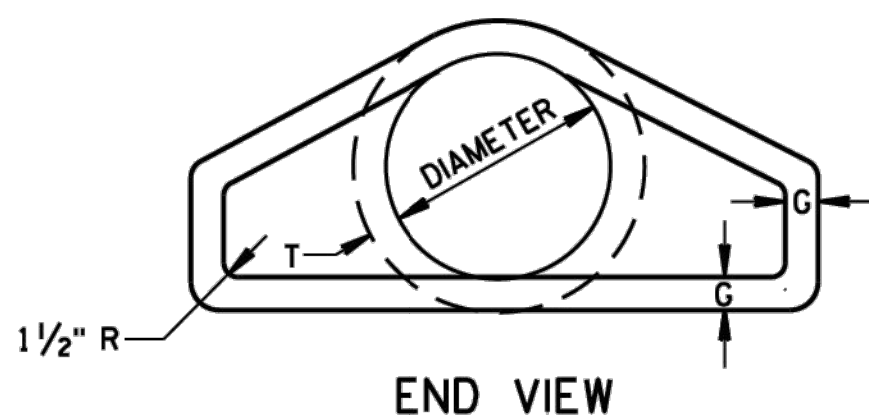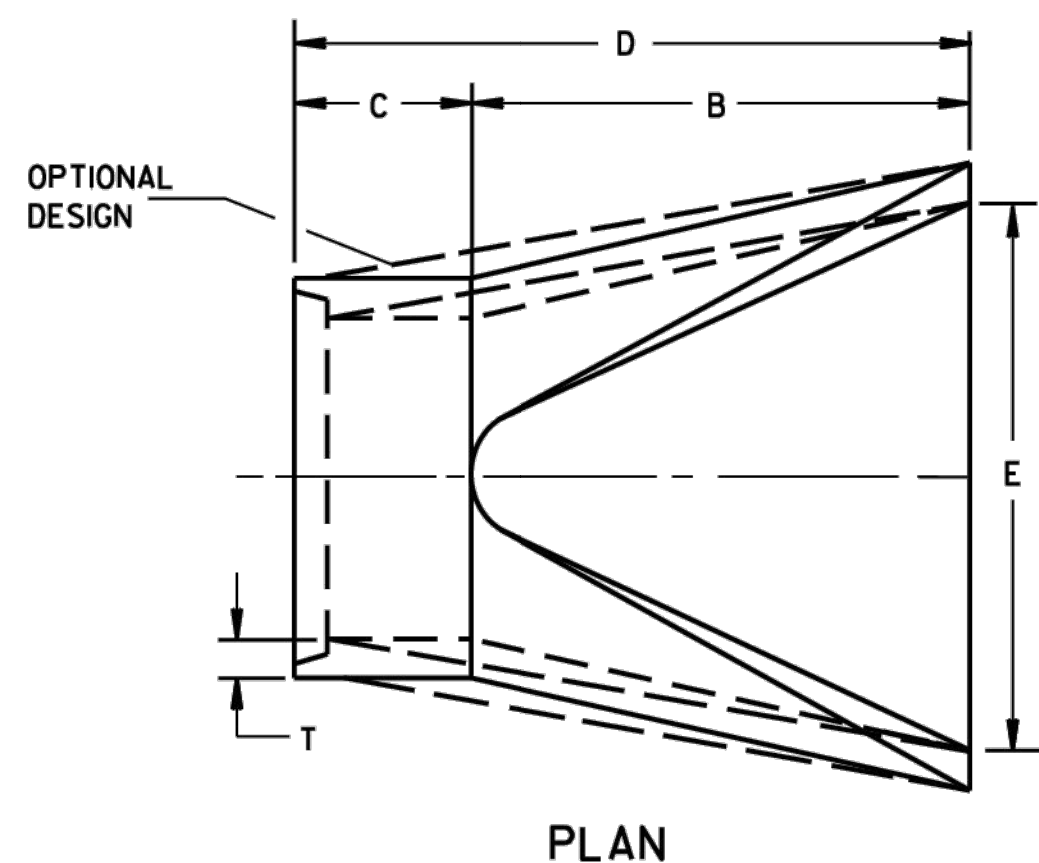

1" WIDE, 12 GA. (0.109" THICK) GALVANIZED STRAP WITH STANDARD 6" X 1/2" BAND BOLT AND NUT

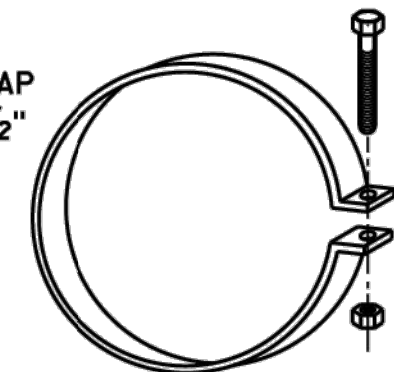

ALTERNATE FOR TYPE 1 CONNECTION
END SECTION CONNECTOR STRAP

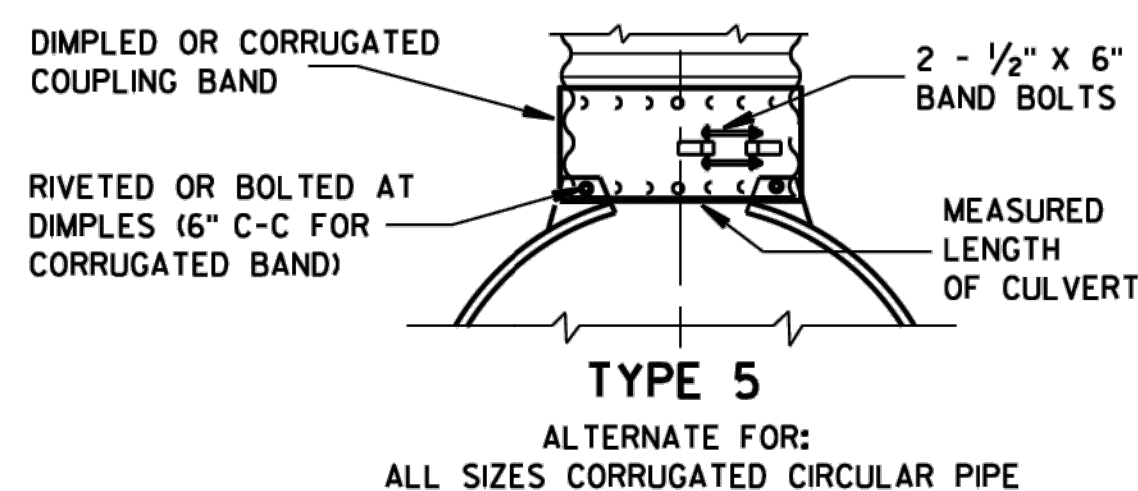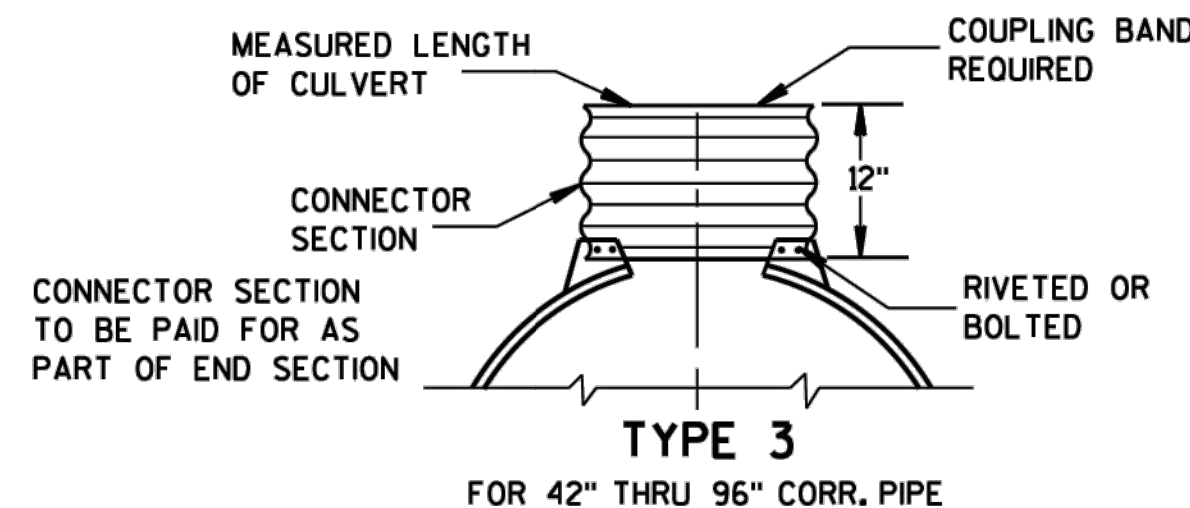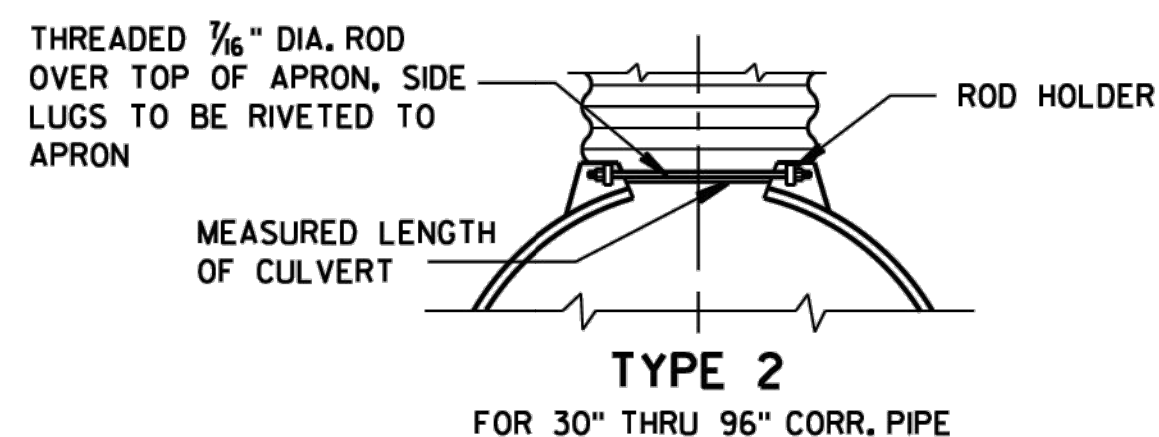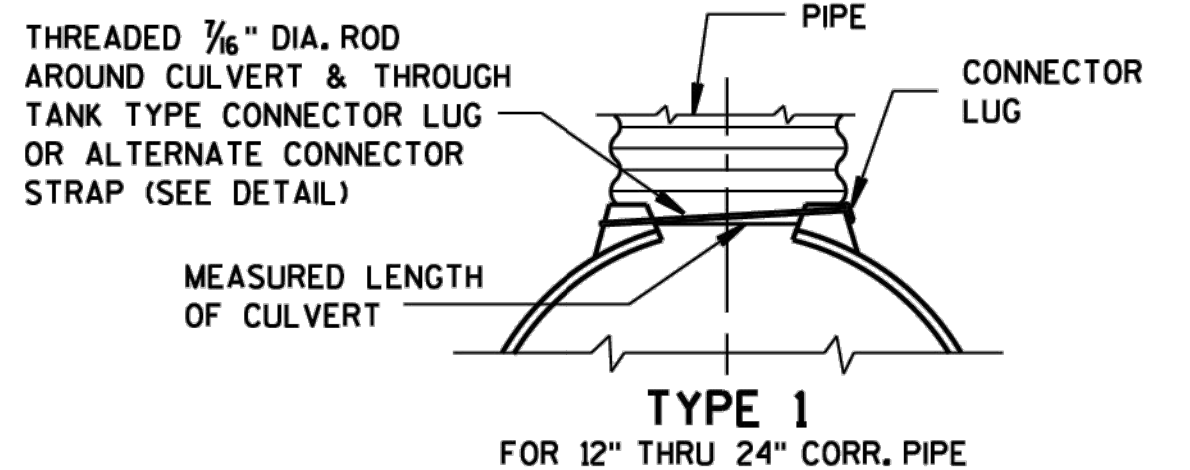


NOTE: DIMPLED BAND FITS OVER OUTSIDE OF ENDWALL, AND CORRUGATED BAND FITS INSIDE ENDWALL. DIMPLED BAND MAY BE USED WITH HELICALLY CORRUGATED PIPE.

FOR CIRCUMFERENTIALLY CORRUGATED PIPE USE ENDWALL CONNECTION DETAILS 1, 2, 3 OR 5 AS APPLICABLE.

FOR HELICALLY CORRUGATED PIPE USE ENDWALL CONNECTION DETAILS 1, 2 OR 5.

FOR HELICALLY CORRUGATED PIPES WITH TWO CIRCUMFERENTIAL CORRUGATIONS AT EACH END USE ENDWALL CONNECTION DETAILS 1, 2 OR 3.

CONNECTION DETAILS

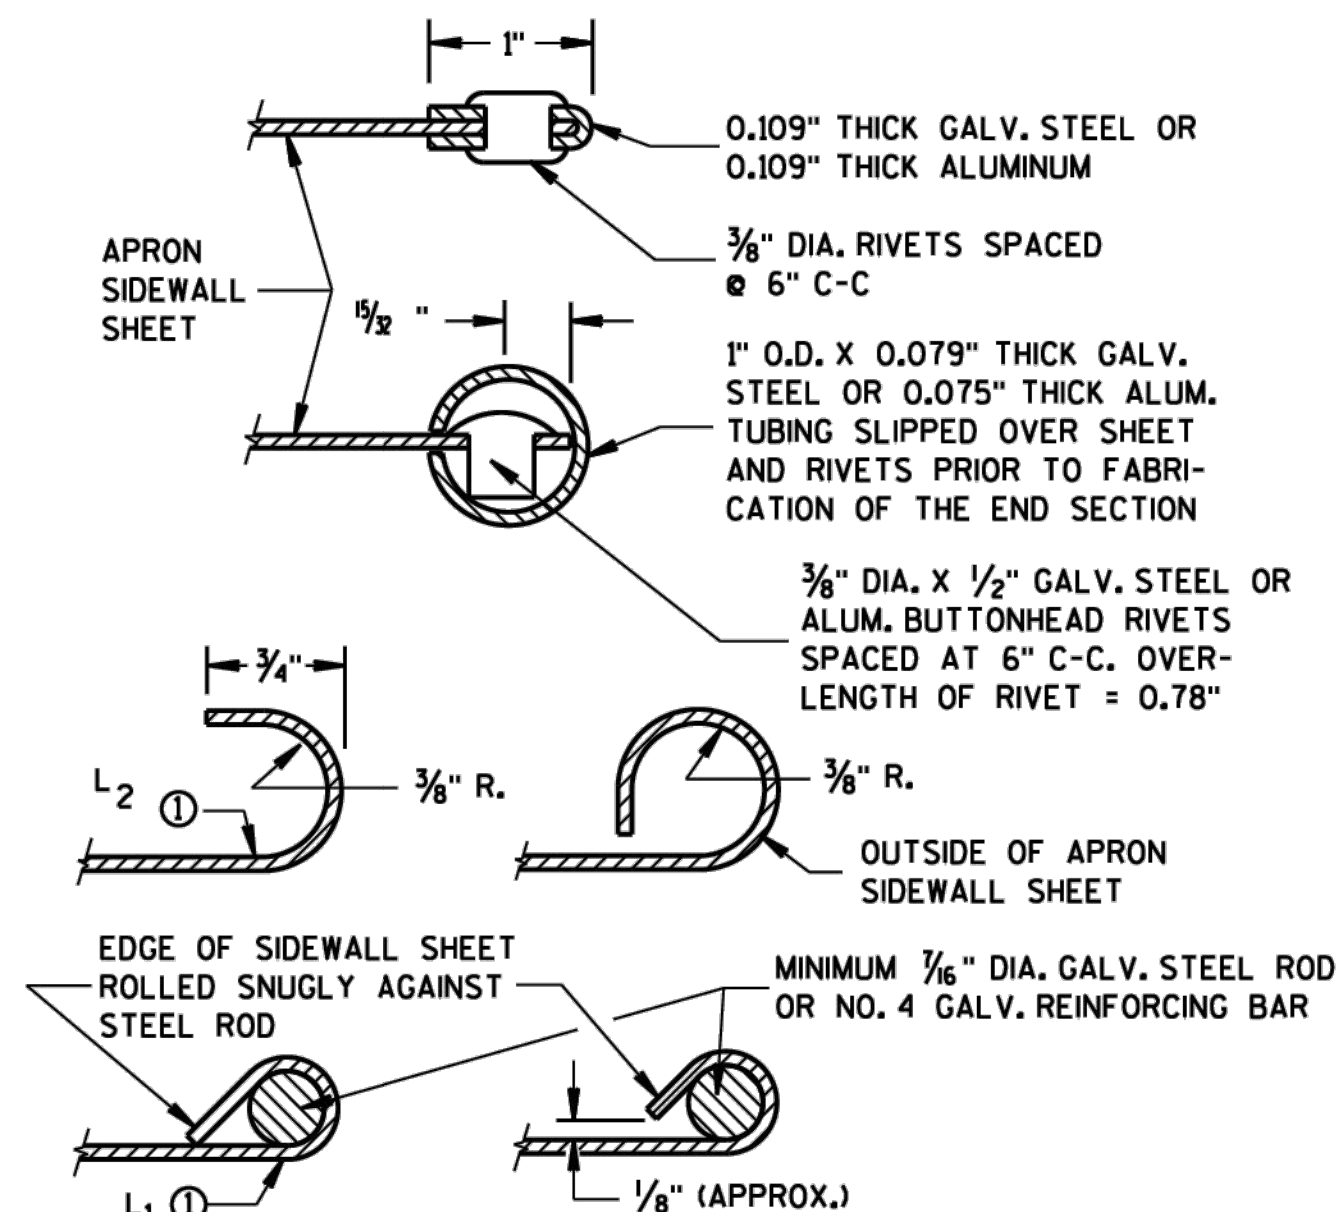

SECTION A-A

GENERAL NOTES

DETAILS OF CONSTRUCTION, MATERIALS AND WORKMANSHIP NOT SHOWN ON THIS DRAWING SHALL CONFORM TO THE PERTINENT REQUIREMENTS OF THE STANDARD SPECIFICATIONS AND THE APPLICABLE SPECIAL PROVISIONS.

CONCRETE CULVERT ENDWALLS MAY NOT BE USED WITH GALVANIZED STEEL OR ALUMINUM CULVERT PIPE OR VICE VERSA. GALVANIZED STEEL OR ALUMINUM ENDWALLS SHALL NORMALLY BE INSTALLED ON CULVERT PIPE OF THE SAME METAL.

ALL THREE PIECE STEEL APRON ENDWALLS FOR 60" DIAMETER PIPE AND LARGER SHALL HAVE 0.109" SIDES AND 0.138" CENTER PANELS. ALL THREE PIECE ALUMINUM APRON ENDWALLS FOR 60" DIAMETER PIPE AND LARGER SHALL HAVE 0.105" SIDES AND 0.134" CENTER PANELS. THE WIDTH OF CENTER PANELS SHALL BE GREATER THAN 20 PERCENT OF THE PIPE PERIMETER.

LAP SEAMS SHALL BE TIGHTLY JOINED BY GALVANIZED RIVETS OR BOLTS FOR STEEL UNITS AND ALUMINUM RIVETS AND BOLTS FOR ALUMINUM UNITS. FOR THE 60" THROUGH 96" DIAMETER APRON ENDWALL SIZES, THE REINFORCED EDGES AND CENTER PANEL SEAMS SHALL BE FURTHER REINFORCED WITH GALVANIZED STEEL OR ALUMINUM STIFFENER ANGLES. THE ANGLES SHALL BE ATTACHED BY GALVANIZED NUTS AND BOLTS FOR STEEL UNITS AND ALUMINUM NUTS AND BOLTS FOR ALUMINUM UNITS.

WHERE TWO OR MORE PIPES WITH APRON ENDWALLS ARE LAID ADJACENT TO EACH OTHER, THEY SHALL BE SEPARATED BY A DISTANCE SUFFICIENT TO PROVIDE A MINIMUM CLEARANCE OF 6 INCHES BETWEEN APRON ENDWALLS.

① FOR PIPE SIZES UP TO 60" DIAMETER, A 180° ROLLED EDGE MAY BE USED INSTEAD OF STEEL ROD REINFORCEMENT. SEE SECTION A-A.

APRON ENDWALLS FOR
CULVERT PIPE

STATE OF WISCONSIN
DEPARTMENT OF TRANSPORTATION

APPROVED
8-30-94 /S/ Rory L. Rhinesmith
DATE CHIEF ROADWAY DEVELOPMENT ENGINEER
FHWA

6

6

S.D.D. 8 F 1-11

S.D.D. 8 F 1-11

PROJECT DATE:	DRAWN BY:	NO.	DATE	REVISION	BY:
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	AJL				
	DWR				



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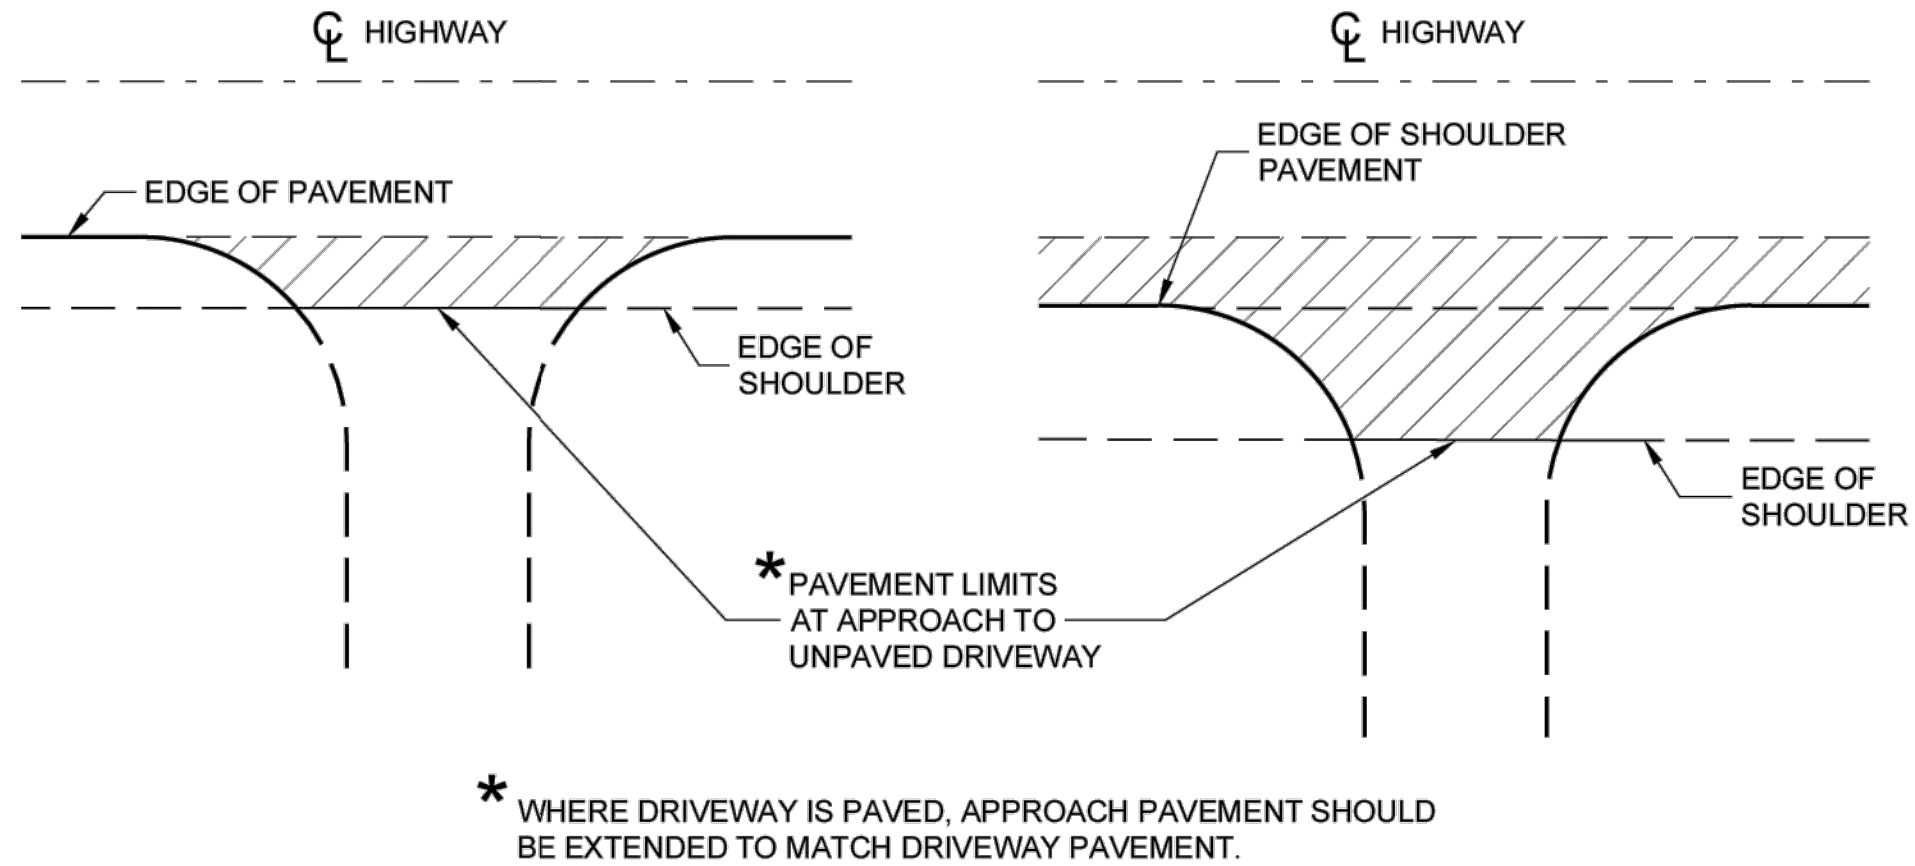
TRINITY EVANGELICAL LUTHERAN CHURCH
CITY OF KIEL
MANITOWOC COUNTY, WISCONSIN

CONSTRUCTION DETAILS

PROJECT NO.
22701002
SHEET
G 6




SDD 08D21 Driveways without Curb and Gutter



PLAN VIEW
(UNPAVED SHOULDER ON HIGHWAY) **PLAN VIEW**
(PAVED SHOULDER ON HIGHWAY)


RURAL DRIVEWAY INTERSECTION DETAIL (NO CURB AND GUTTER OR SIDEWALK)

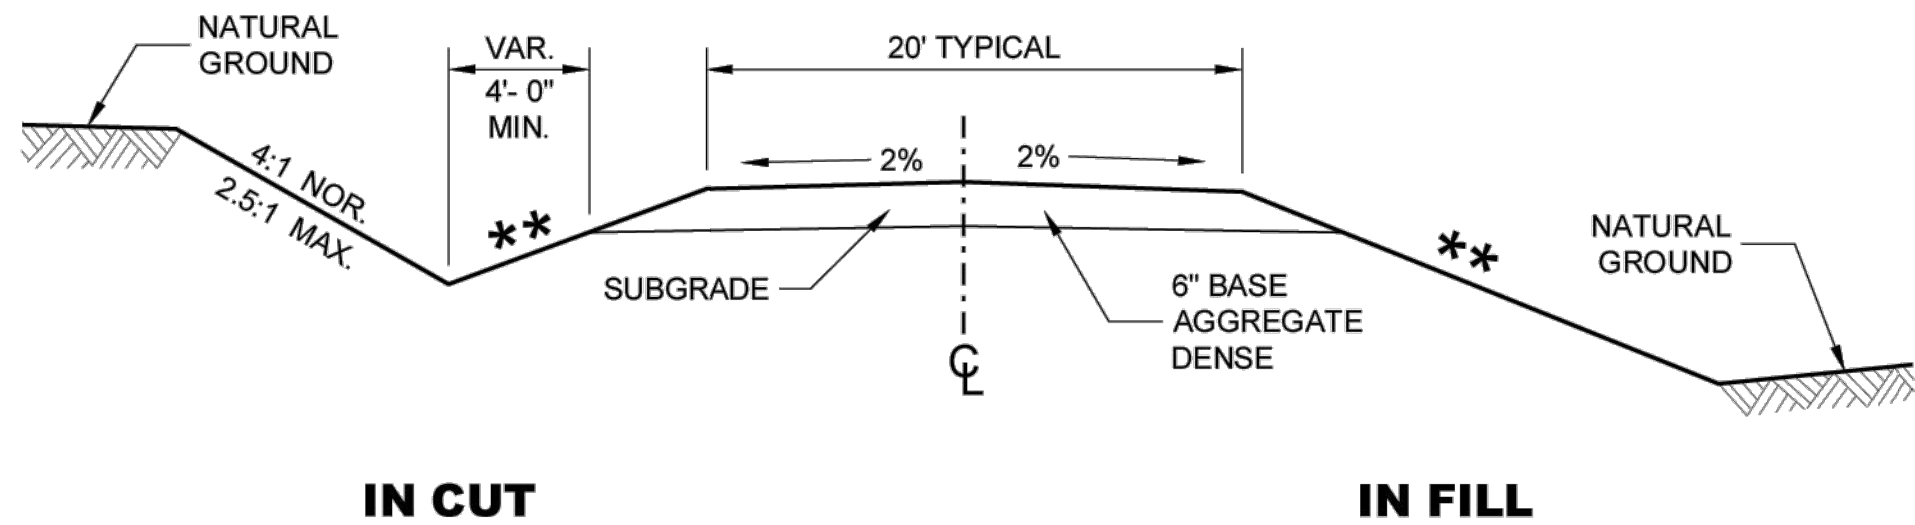


**TYPICAL CROSS SECTION FOR
PRIVATE DRIVE OR FIELD ENTRANCE
AGGREGATE SURFACE**

** SLOPE CAN VARY WITH SPEED. SEE 11-45-30.6.2

POSTED SPEED MPH	MAX. SLOPE
<35	4:1
≥ 35 TO < 60	6:1
≥60	10:1

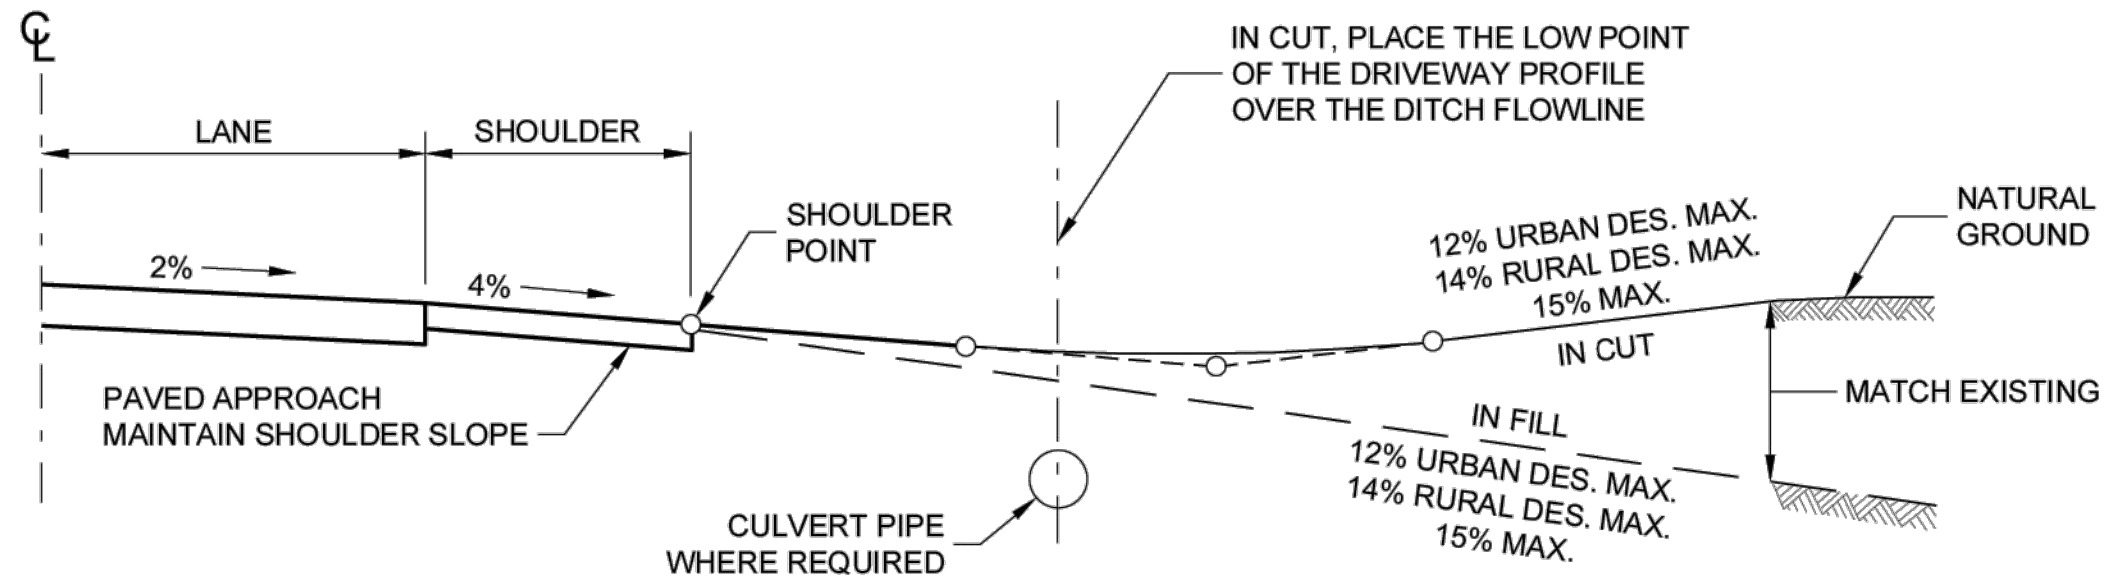

TYPICAL DRIVEWAY PROFILES

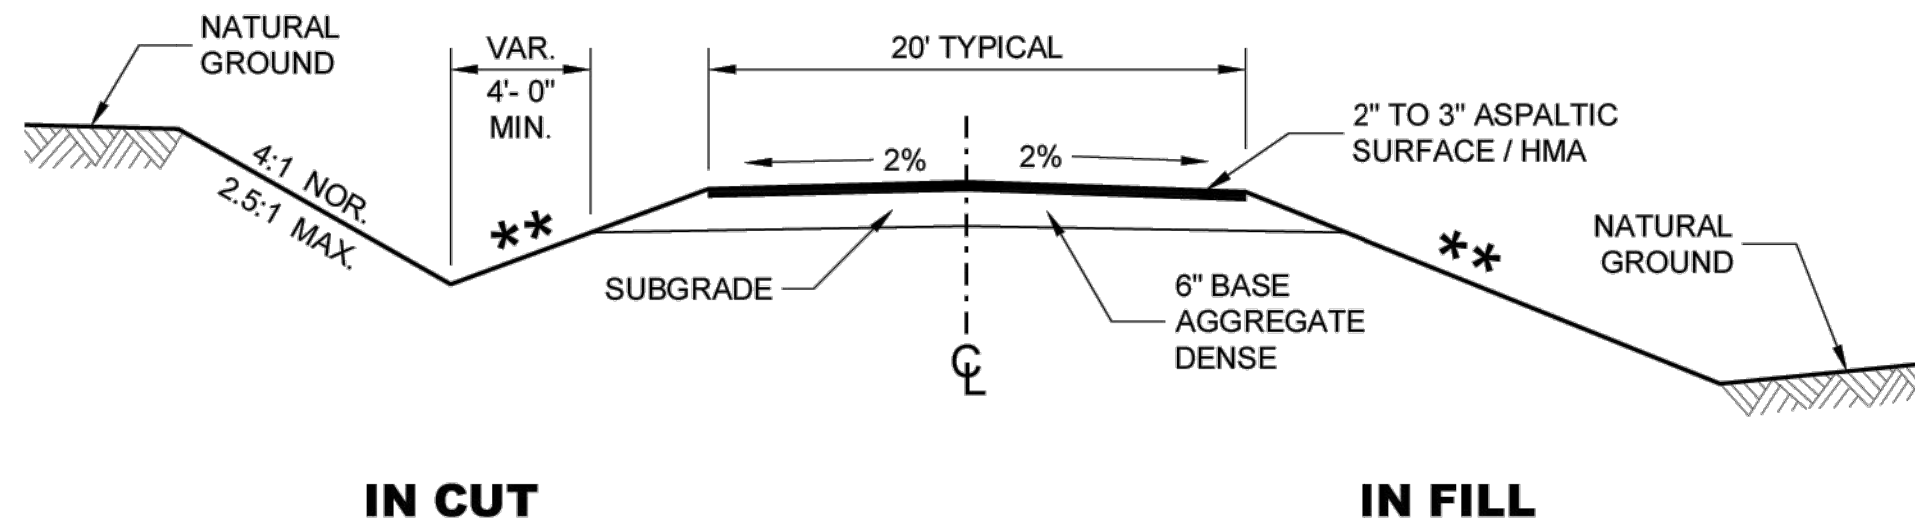

**TYPICAL CROSS SECTION FOR
PRIVATE DRIVE OR FIELD ENTRANCE
ASPHALTIC SURFACE**

DRIVEWAYS WITHOUT CURB AND GUTTER

STATE OF WISCONSIN
DEPARTMENT OF TRANSPORTATION

APPROVED
December 2017
DATE
/S/ Rodney Taylor
ROADWAY STANDARDS DEVELOPMENT
UNIT SUPERVISOR
FHWA

PROJECT DATE:	DRAWN BY:	EAE	NO.	DATE	REVISION	BY:
	DESIGNED BY:	AJL				
	CHECKED BY:	DWR				

PLOT DATE: 1/22/2026 2:19 PM, G:\22\22701\22701002\CADD\Construction Documents\22701002 General Sheets.dwg




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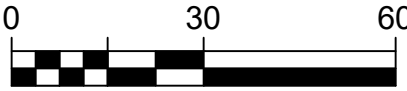
CONSTRUCTION DETAILS

PROJECT NO.
22701002
SHEET
G 7



BENCHMARK TABLE

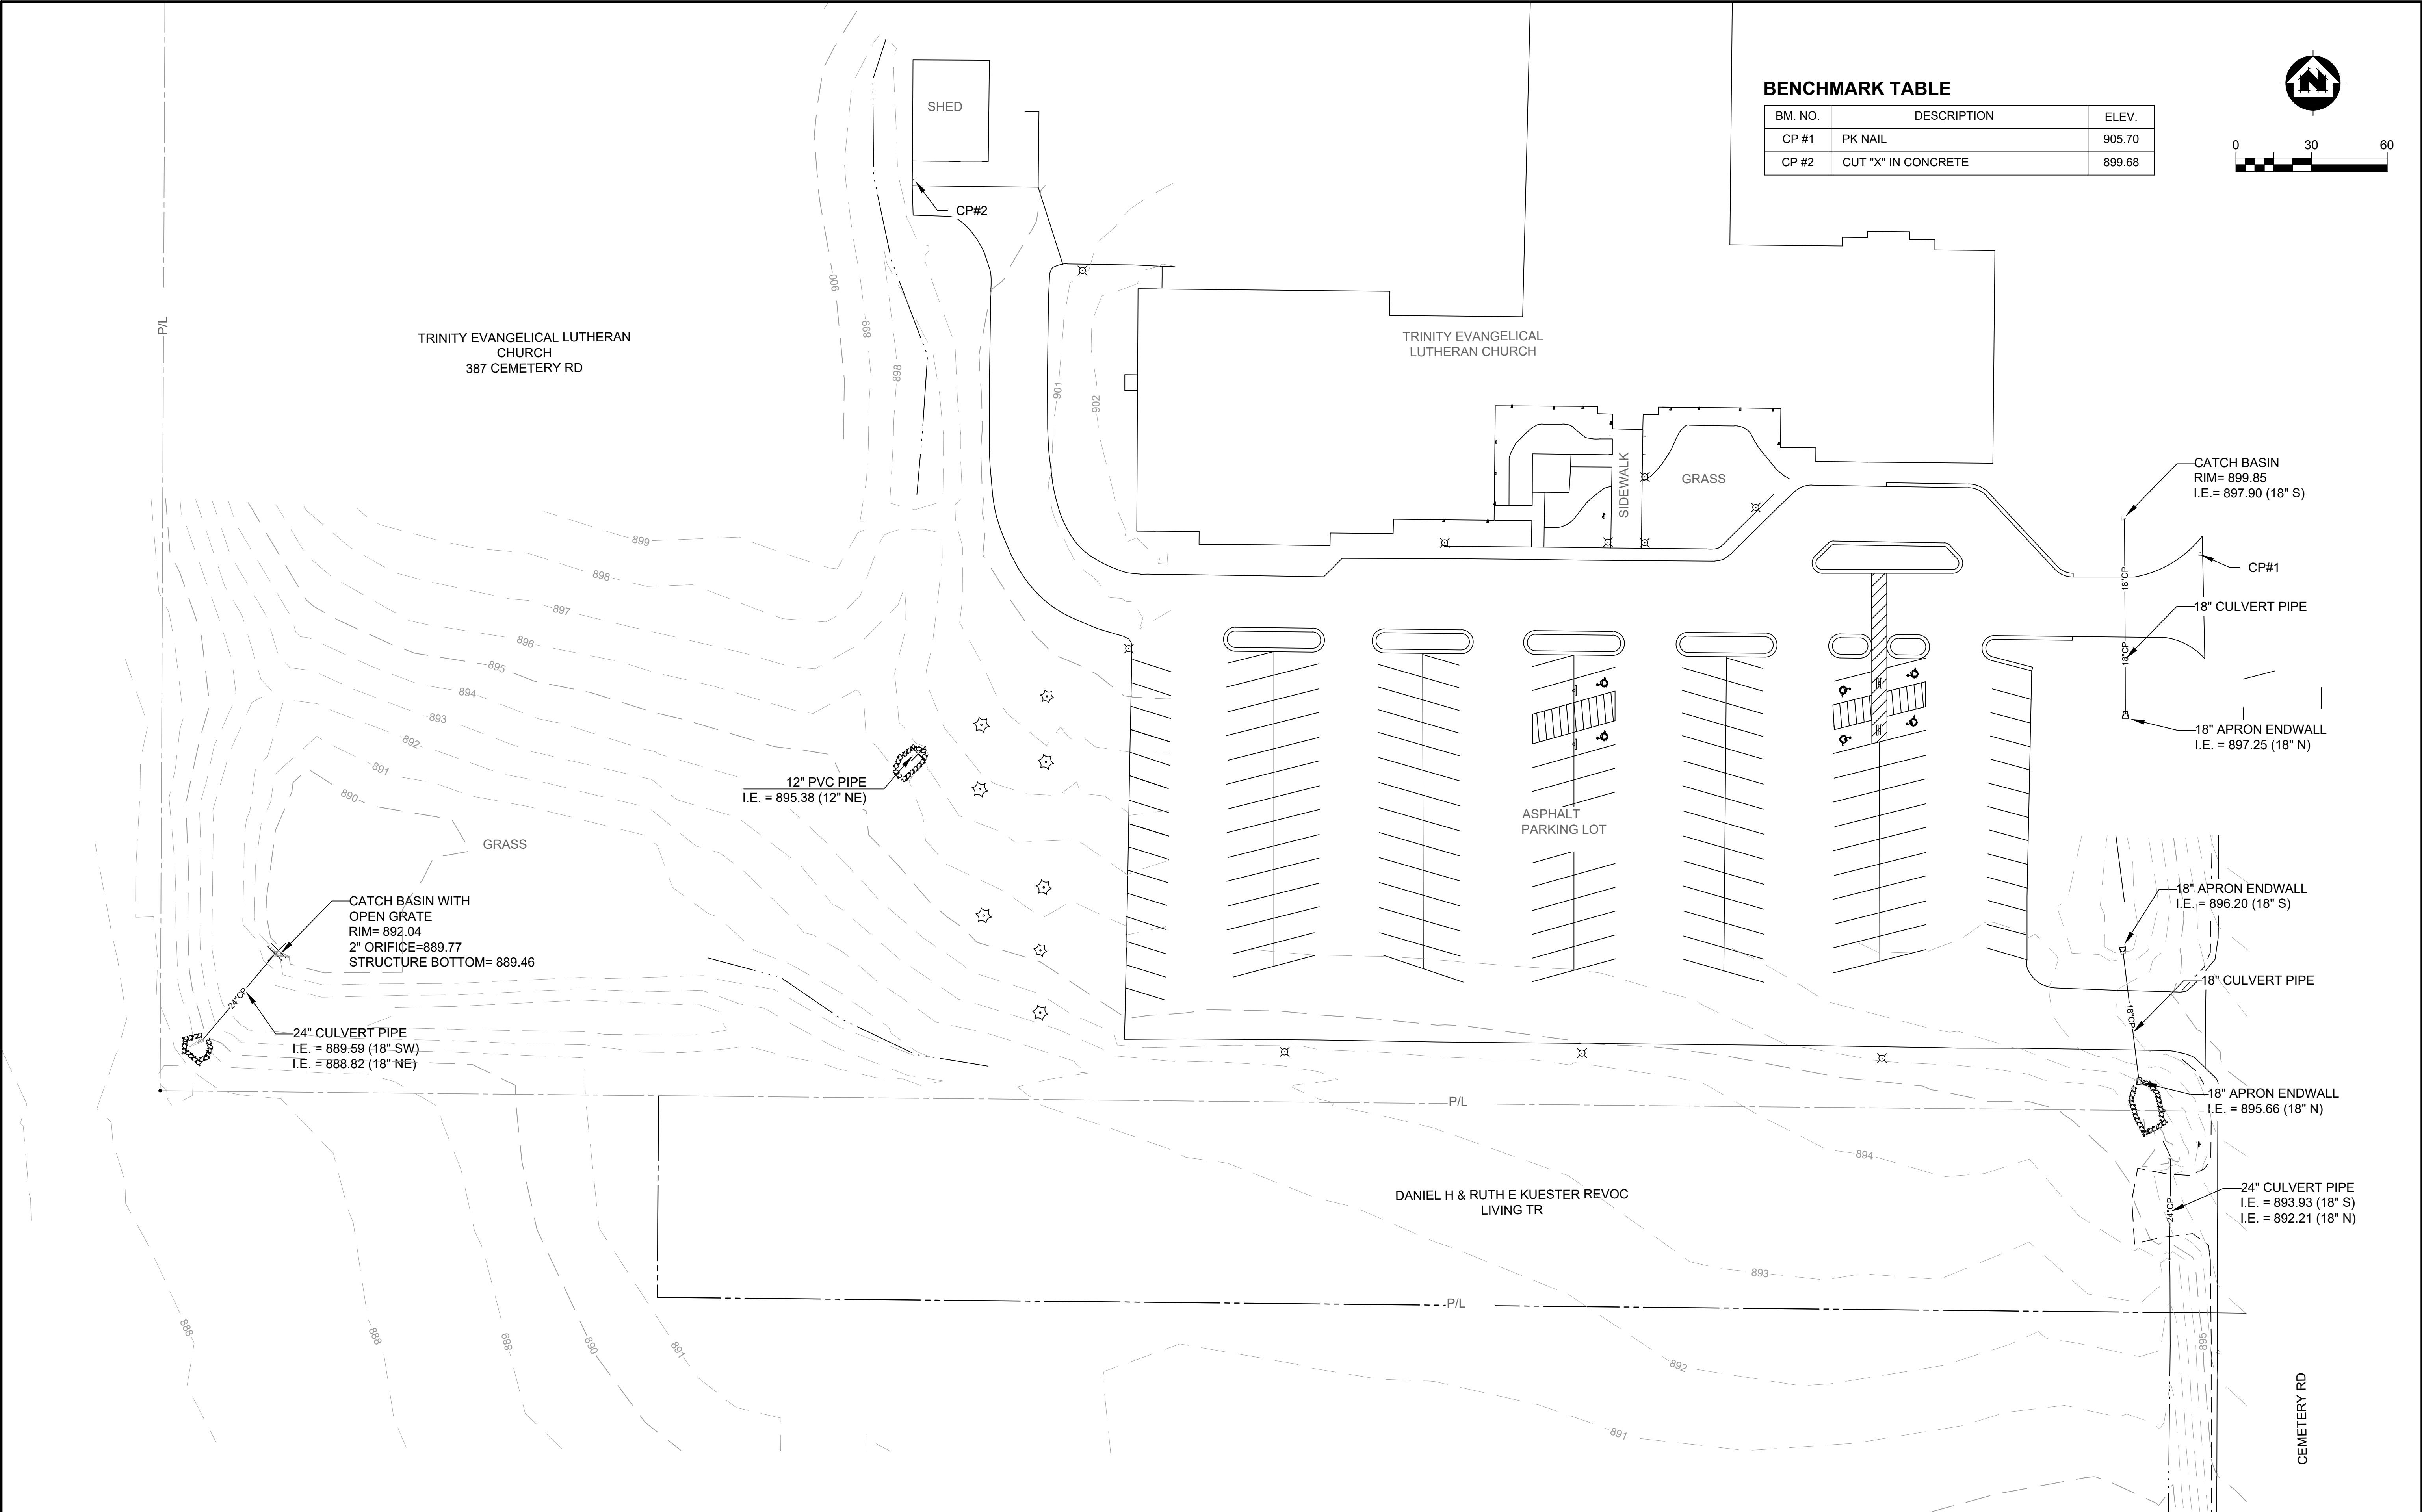BM. NO.	DESCRIPTION	ELEV.
CP #1	PK NAIL	905.70
CP #2	CUT "X" IN CONCRETE	899.68



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EXISTING SITE PLAN



PROJECT NO:
22701002

SHEET
ST 1

- LEGEND:**
- APPROXIMATE DISTURBANCE LIMITS
 - xxxxxxx PIPE REMOVAL
 - //// SAW CUT
 - SILT FENCE (SEE DETAIL)
 - ASPHALT REMOVAL
 - BUILDING REMOVAL
 - CONCRETE REMOVAL
 - LANDSCAPING REMOVAL
 - TURF REMOVAL
 - EROSION MAT (WISDOT URBAN TYPE A)


SEE SHEETS G3 AND G4 FOR
ADDITIONAL NOTES & REQUIREMENTS

- GENERAL NOTES:**
- THE CONTRACTOR SHALL INSTALL INLET PROTECTION IN ALL EXISTING & PROPOSED STORM INLETS & CATCH BASIN (SEE DETAIL) UNTIL THE SITE HAS BEEN STABILIZED.(INCLUDED IN EROSION CONTROL BID ITEM).
 - THE CONTRACTOR SHALL INSTALL TRACKING PAD(S) AT ALL ACCESS LOCATIONS TO PROJECT STREET (SEE DETAIL).

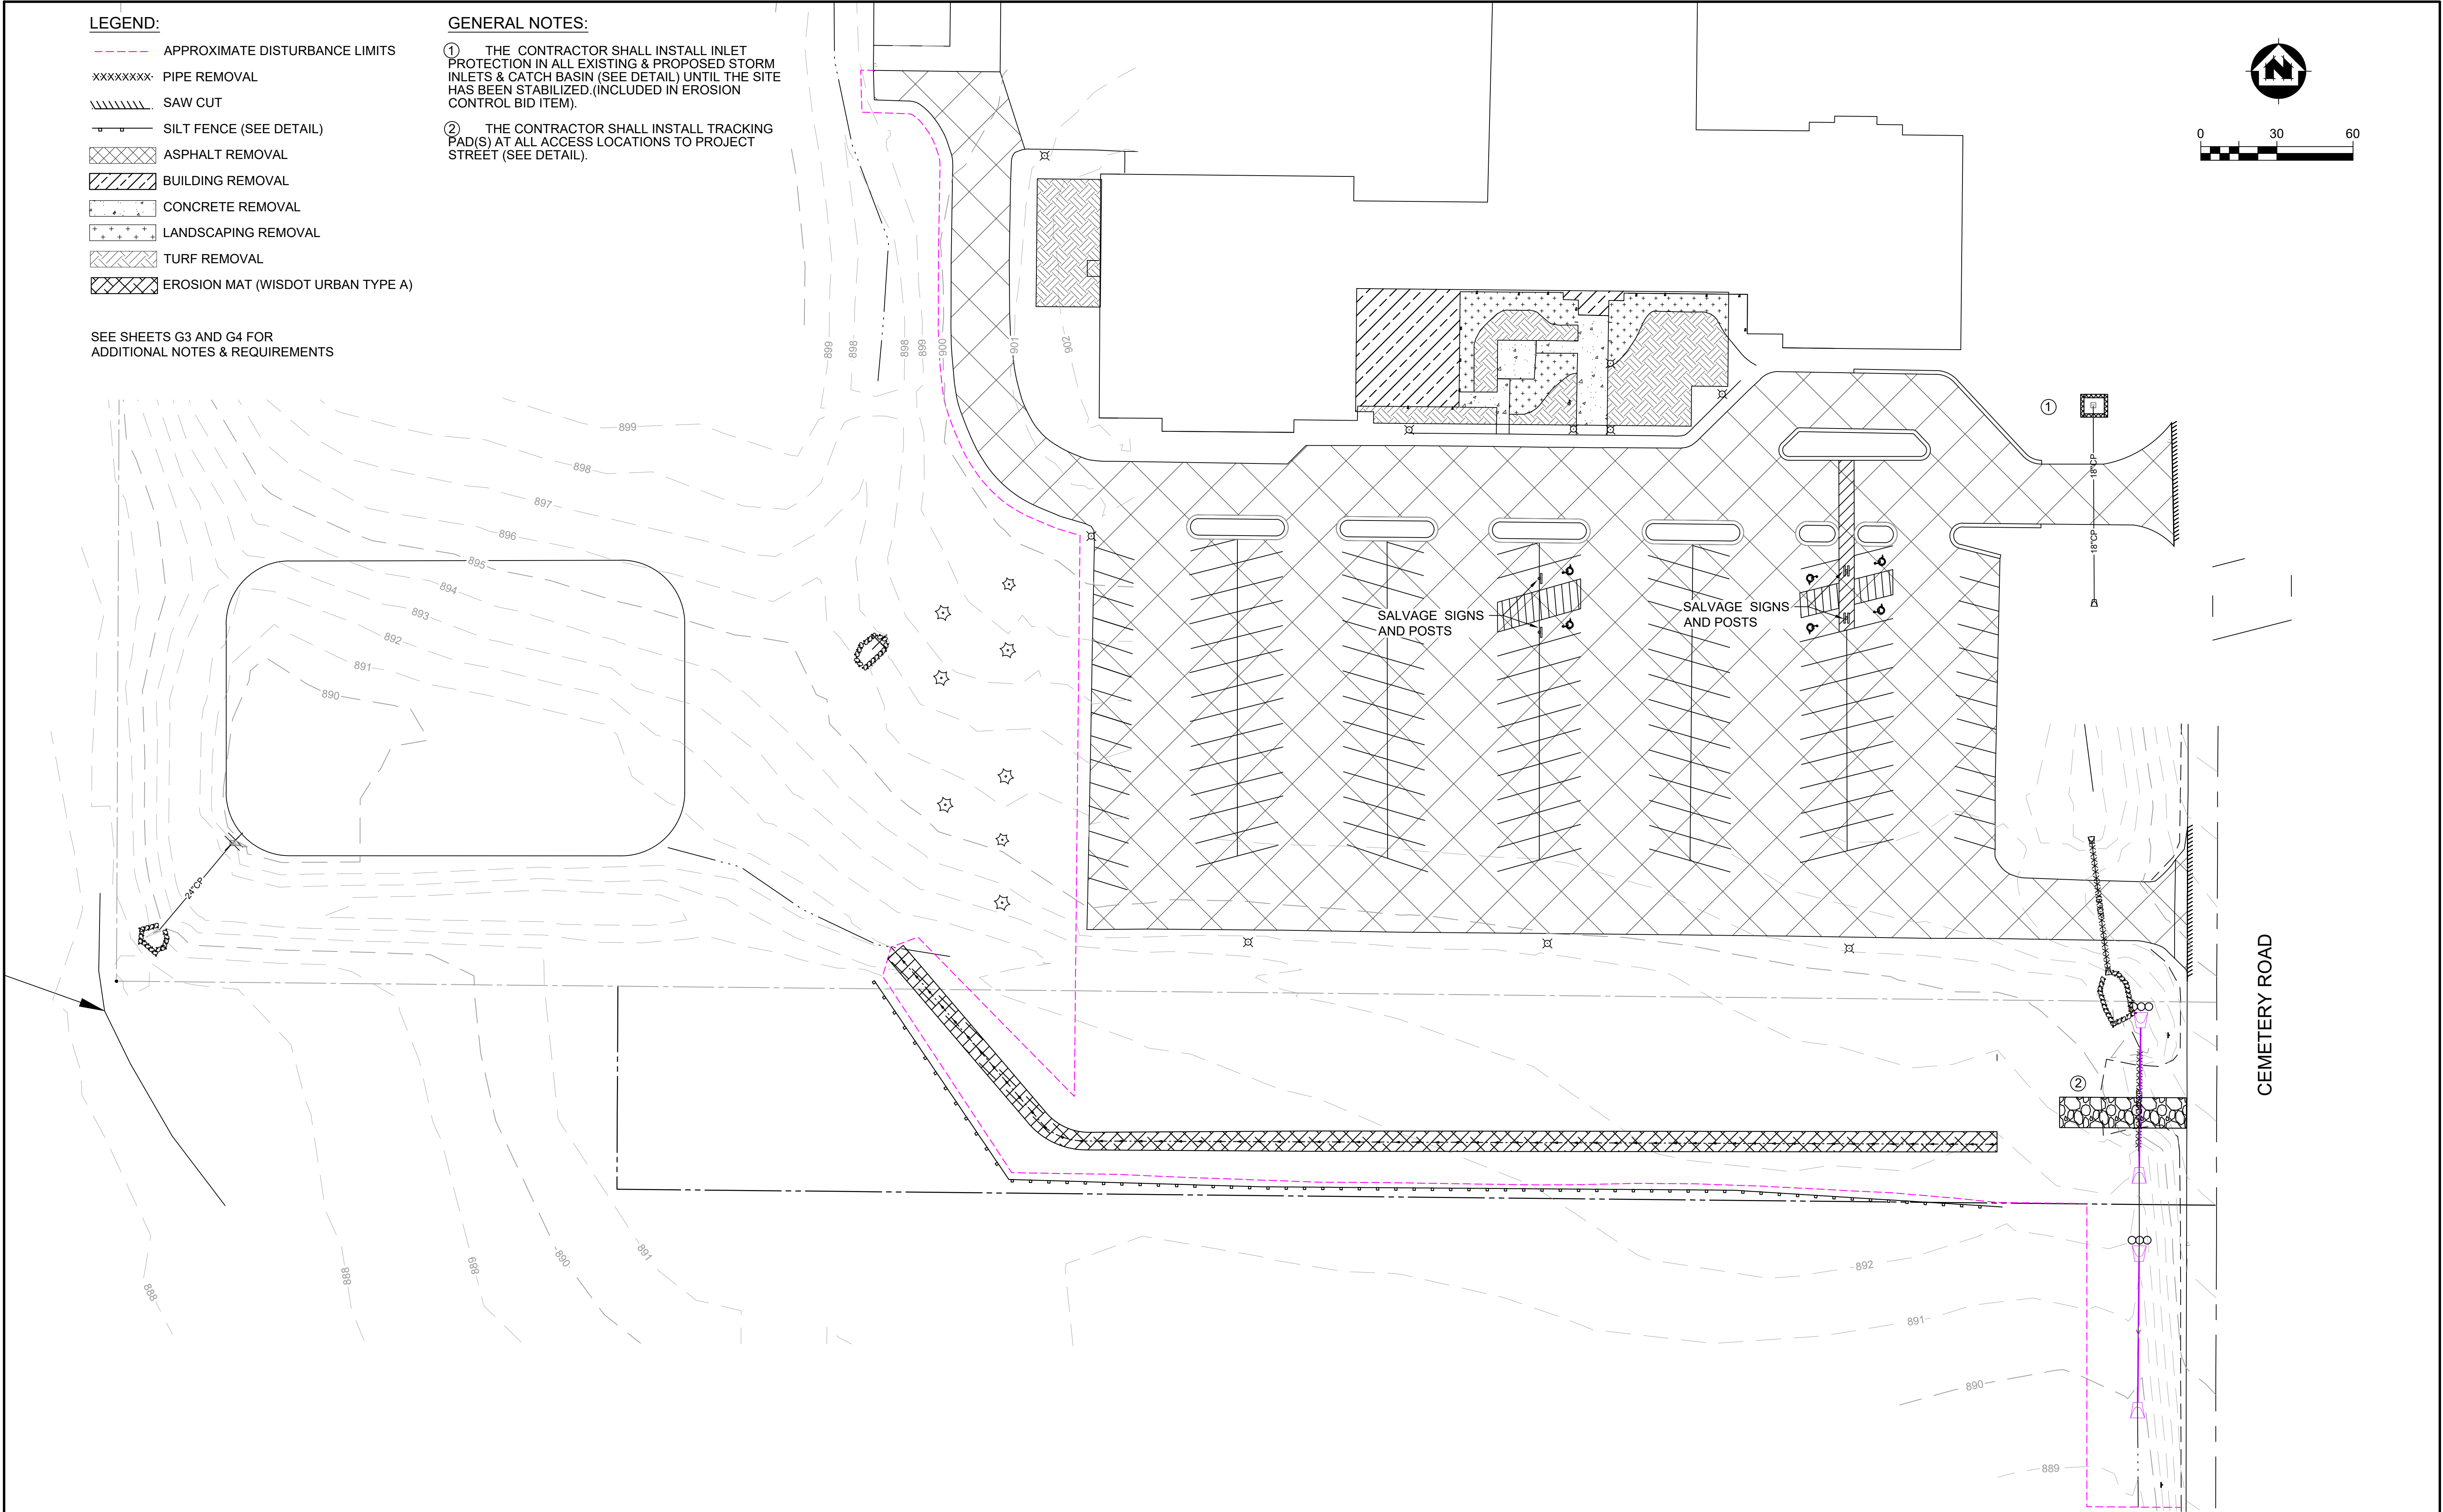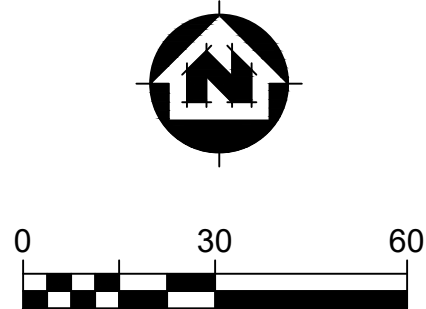

PROJECT DATE:	DRAWN BY:	EAE	NO.	DATE	REVISION	BY:
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	CHECKED BY:	DWR				

PLOT DATE: 1/22/2026 2:20 PM, G:\22\22701\22701002\CADD\Construction Documents\22701002 Erosion Control and Removals Plan.dwg




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EROSION CONTROL AND REMOVALS PLAN

PROJECT NO:
22701002
SHEET
ST 2




- NOTES:
1. ALL ASPHALT MILLING SHALL REMAIN ON SITE AND BE USED FOR BASE AGGREGATE.
 2. ADDED IMPERVIOUS AREA = 0.56 ACRES
 3. LAND PURCHASE AREA = 0.96 ACRES

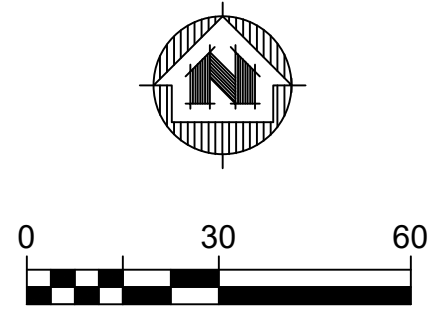PARKING STALLS TABLE

EXISTING PARKING STALLS	146
ADDITIONAL PARKING STALLS	94
TOTAL PARKING STALLS	240

- LEGEND
- ① 4-INCH THICK ASPHALT PAVEMENT
 - ② MILL AND OVERLAY PAVEMENT
 - ③ PAVEMENT MARKING, EPOXY, 4-INCH, WHITE (SEE DETAIL SHEET G 5)
 - ④ PAVEMENT MARKING, EPOXY, WHITE, TYPE 1 ARROW (SEE DETAIL SHEET G 5)
 - ⑤ RELOCATED FIELD ENTRANCE
 - ⑥ SAW CUT
 - ⑦ PAVEMENT MARKING, EPOXY, WHITE, ADA SYMBOL (SEE DETAIL SHEET G 5)
 - EOP EDGE OF PAVEMENT
 - EOG EDGE OF GRAVEL

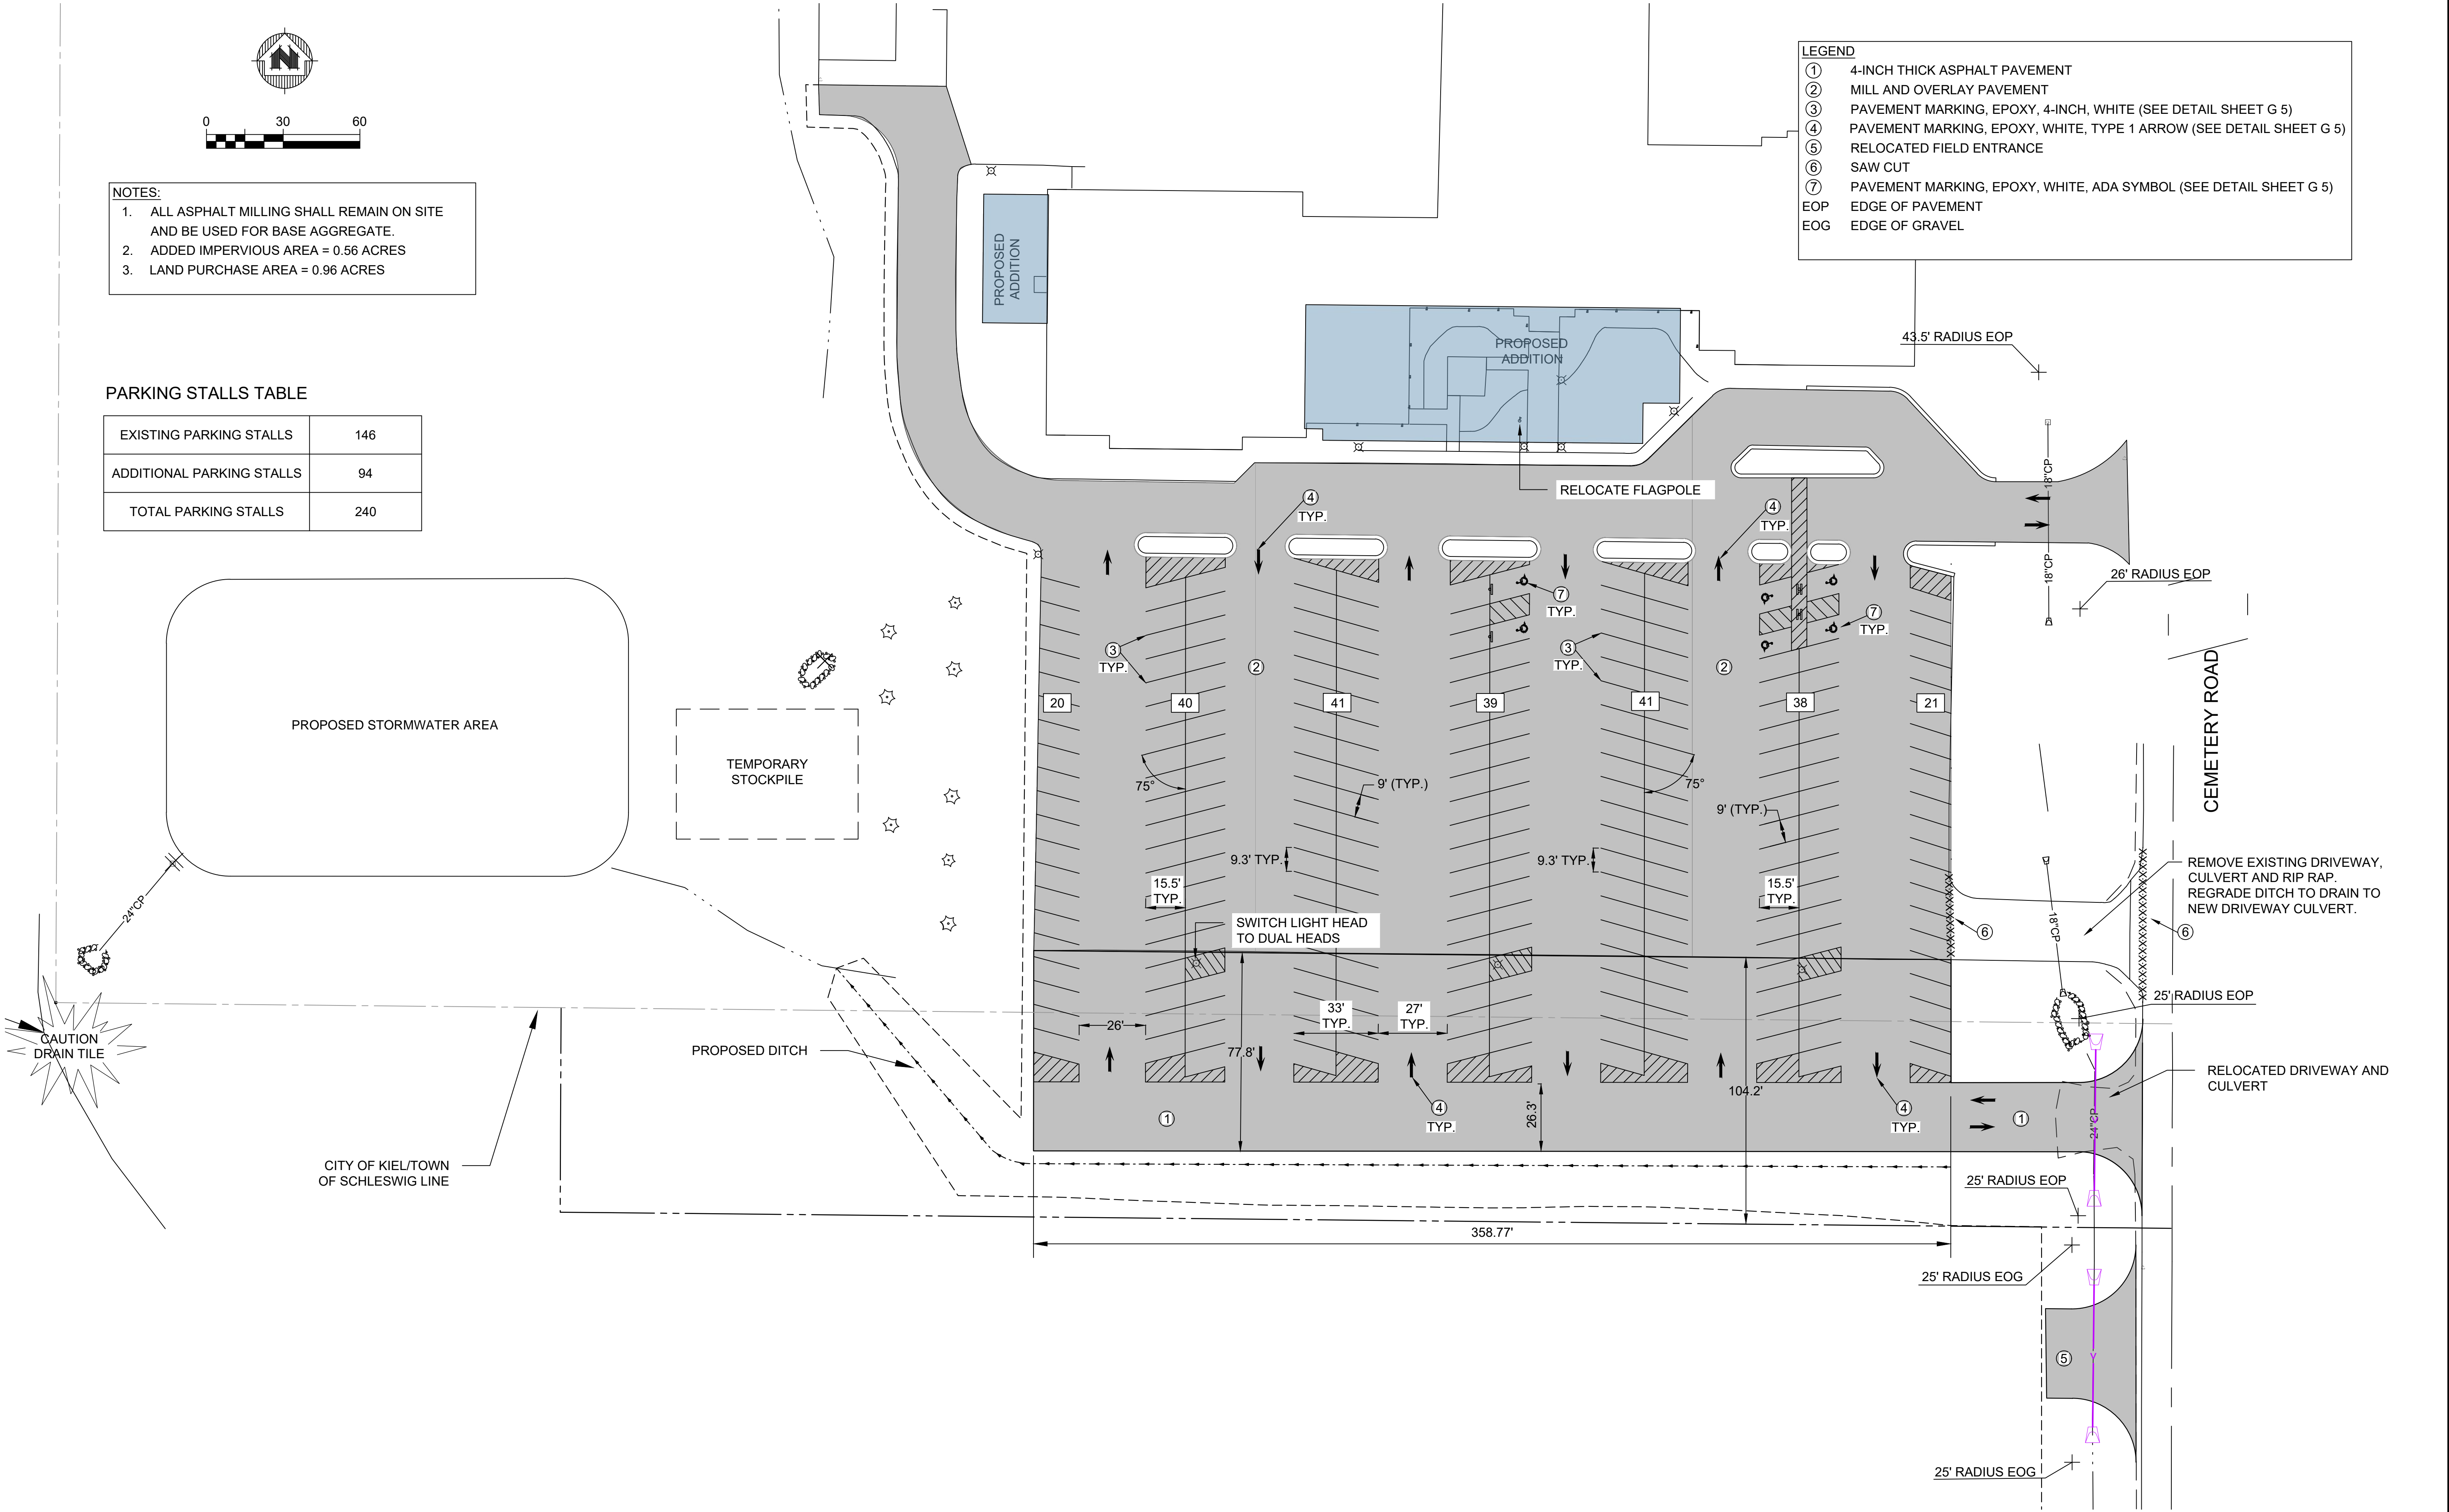

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	CHECKED BY:	DWR	-	-	-	-

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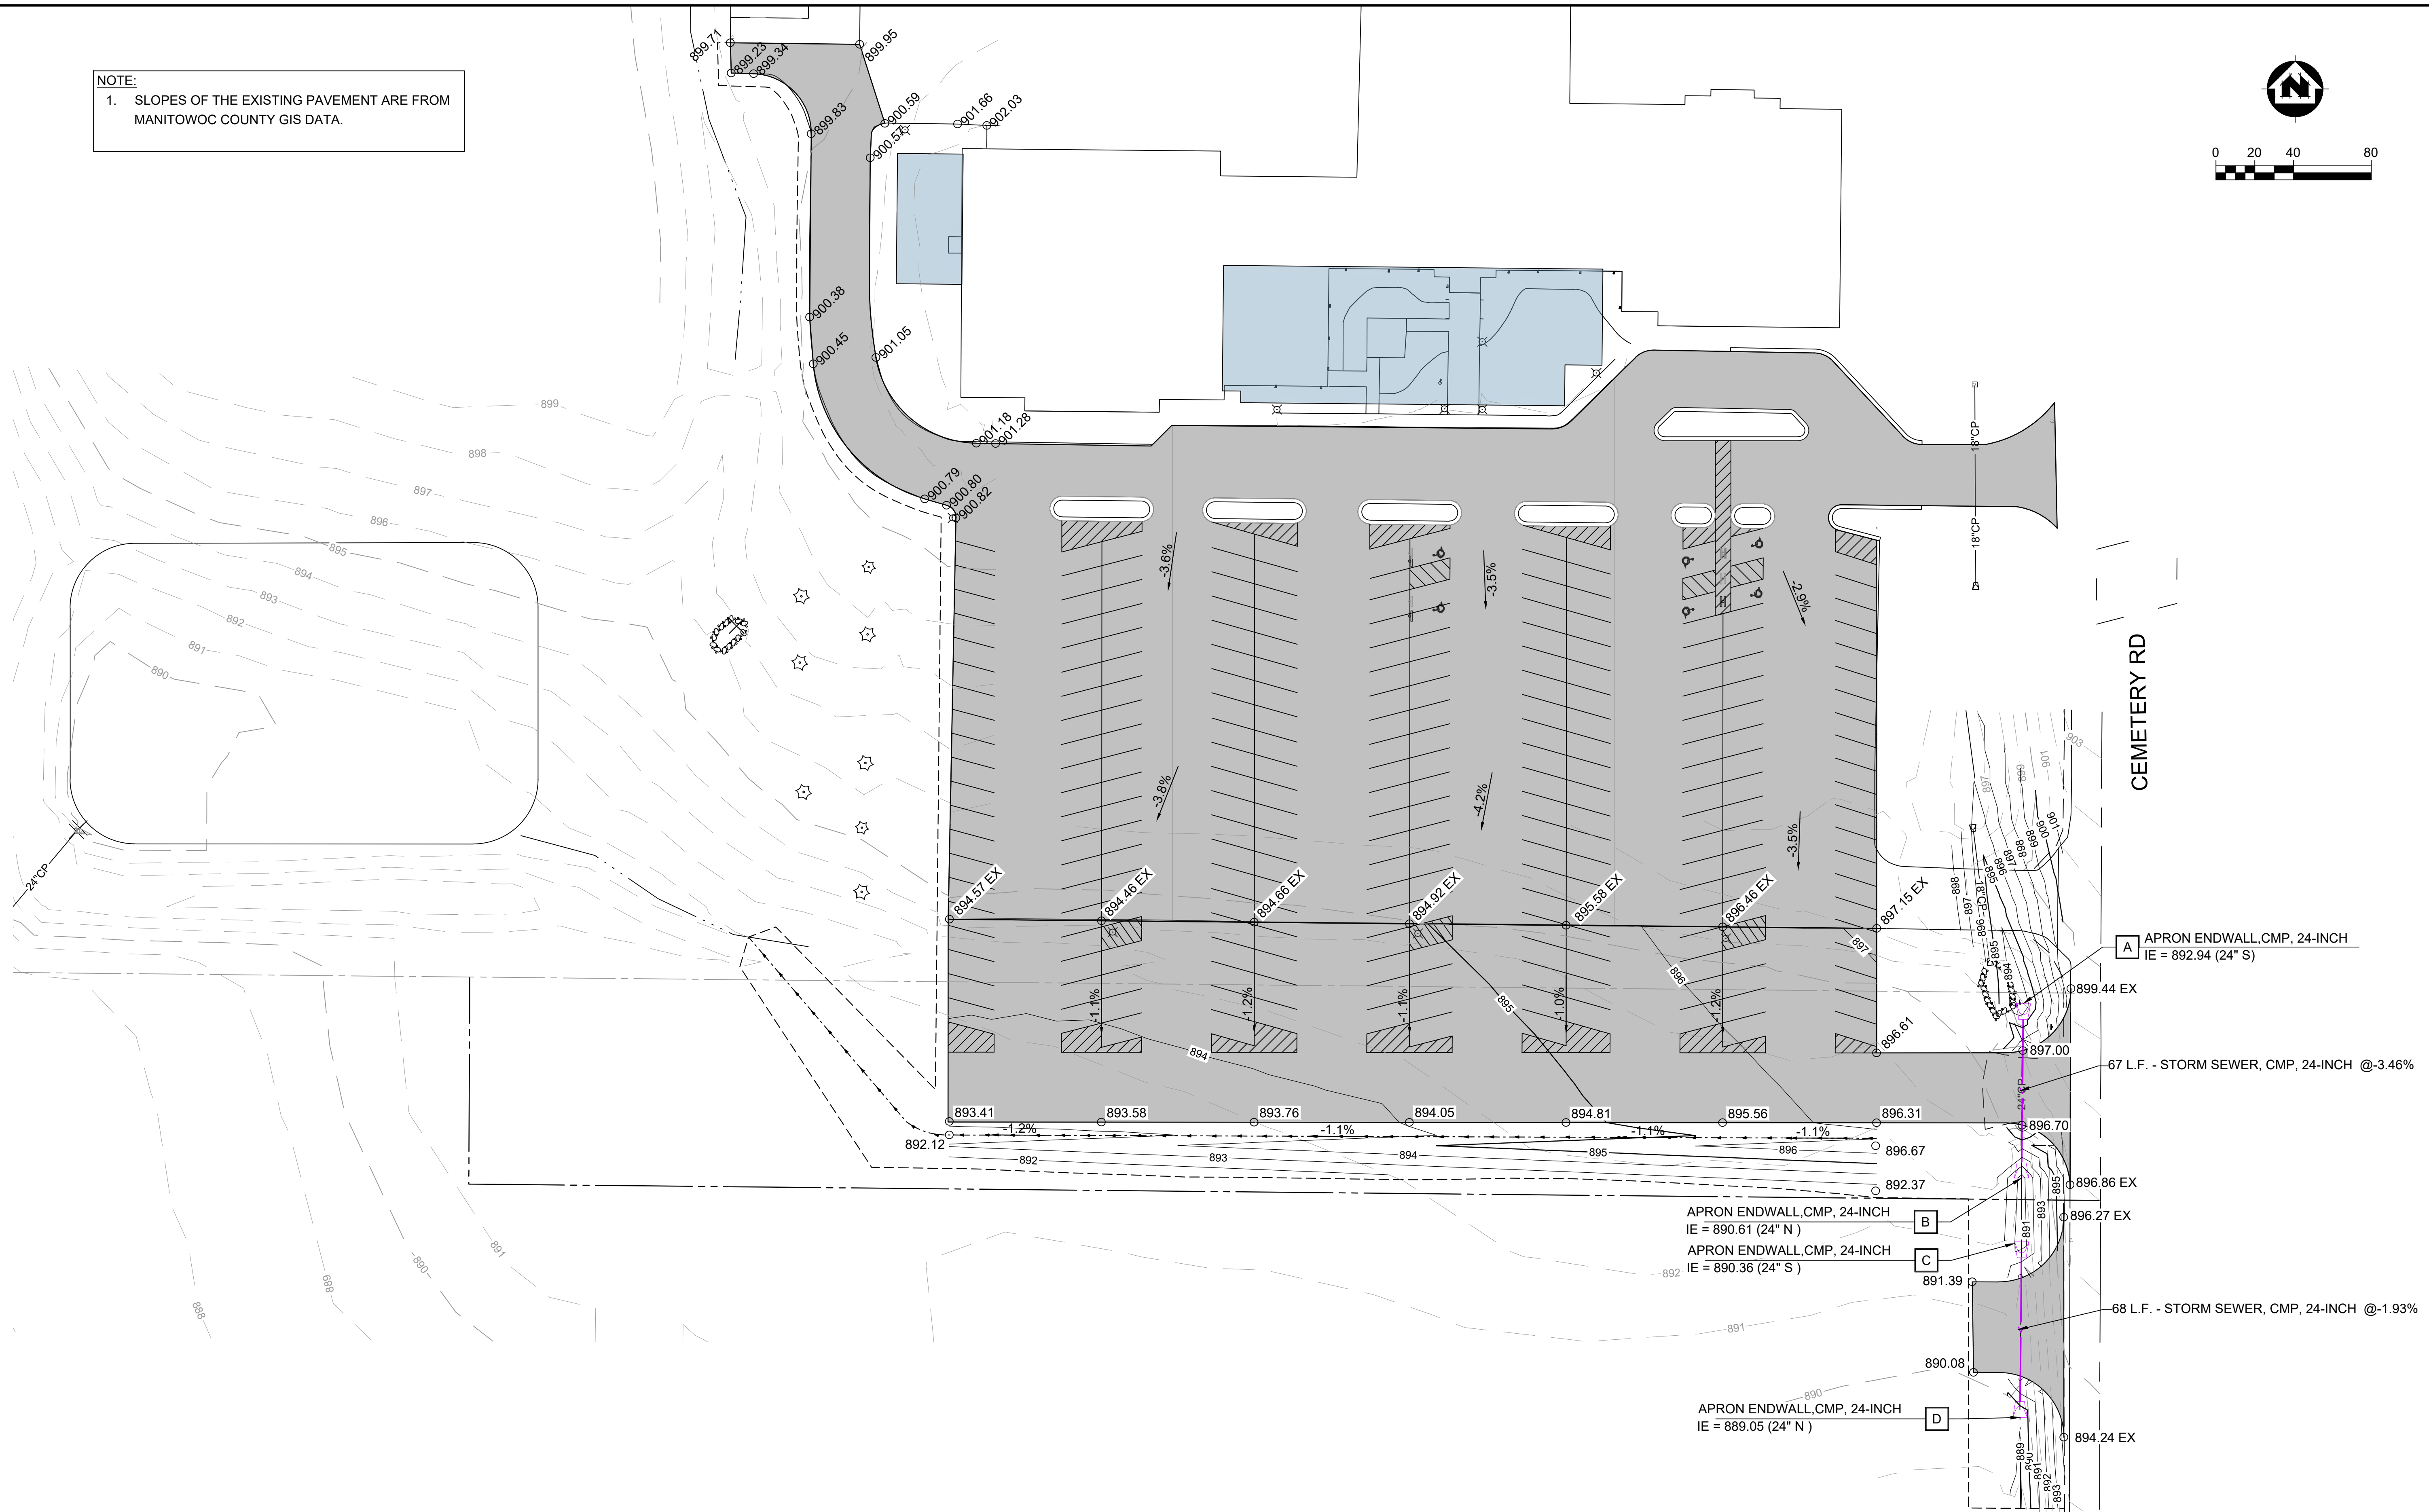
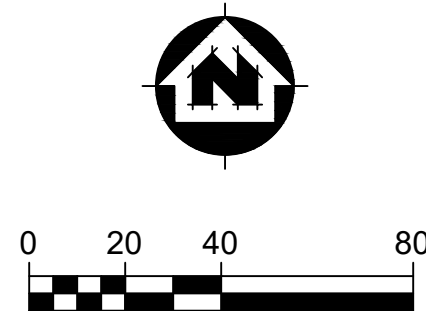
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PROPOSED SITE PLAN


PROJECT NO:
22701002
SHEET
ST 3

NOTE:
1. SLOPES OF THE EXISTING PAVEMENT ARE FROM
MANITOWOC COUNTY GIS DATA.



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	CHECKED BY:	DWR				

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MANITOWOC COUNTY, WISCONSIN

GRADING PLAN

PROJECT NO:
22701002
SHEET
ST 4



Always a Better Plan
100 Camelot Drive
Fond du Lac, WI 54935
920-926-9800
excelengineer.com

PROJECT INFORMATION

PROPOSED ADDITION FOR:
TRINITY LUTHERAN CHURCH
387 CEMETERY ROAD • KIEL, WI 53042

PROFESSIONAL SEAL

PRELIMINARY DATES

DEC. 12, 2025
JAN. 9, 2026

JOB NUMBER

250315500

SHEET NUMBER

A1.1


NOT FOR CONSTRUCTION

SYMBOLS LEGEND

- INTERIOR WALL TYPE
-SEE SHEET -
- EXIT SIGNAGE
- FIRE EXTINGUISHER
-SEE AS SHEETS
- FIRE EXTINGUISHER w/ CABINET
-SEE AS SHEETS
- EXISTING WALL TO REMAIN
- NEW STUD WALL
- NEW MASONRY VENEER
- NEW C.M.U. WALL
- (2) HOUR
FIRE RATED
- EXISTING DOOR
TO REMAIN
- NEW DOOR
- ALIGN FINISH


GENERAL NOTES

- NOT ALL INFILL OF OPENINGS AND PATCHING ARE SHOWN. INFILL ALL WALL OPENINGS TO MATCH EXISTING WALL CONSTRUCTION. PATCH TO MATCH ADJACENT SURFACES AND FINISH WHERE PIPES, CONDUIT, DUCTWORK, RECEPTACLES, SWITCHES, ETC. ARE REMOVED.
- AT EXISTING CONSTRUCTION, INTERIOR DIMENSIONS ARE FROM EXISTING FACE OF FINISH TO NEW FACE OF STUD.
- ALL INTERIOR DIMENSIONS ARE FROM FACE-OF-STUD TO FACE-OF-STUD OR FACE OF MASONRY.
- LOCATE ALL DOORS IN METAL STUD AND MASONRY WALLS 4" FROM ADJACENT WALL UNLESS NOTED OTHERWISE.
- PROVIDE WOOD BLOCKING FOR ANY FURNISHINGS BY OWNER. VERIFY LOCATIONS REVIEW ON SITE W/ OWNER DURING CONSTRUCTION WHEN STUDS ARE EXPOSED. SEE INT. ELEVATIONS FOR ADDITIONAL BLOCKING LOCATIONS.

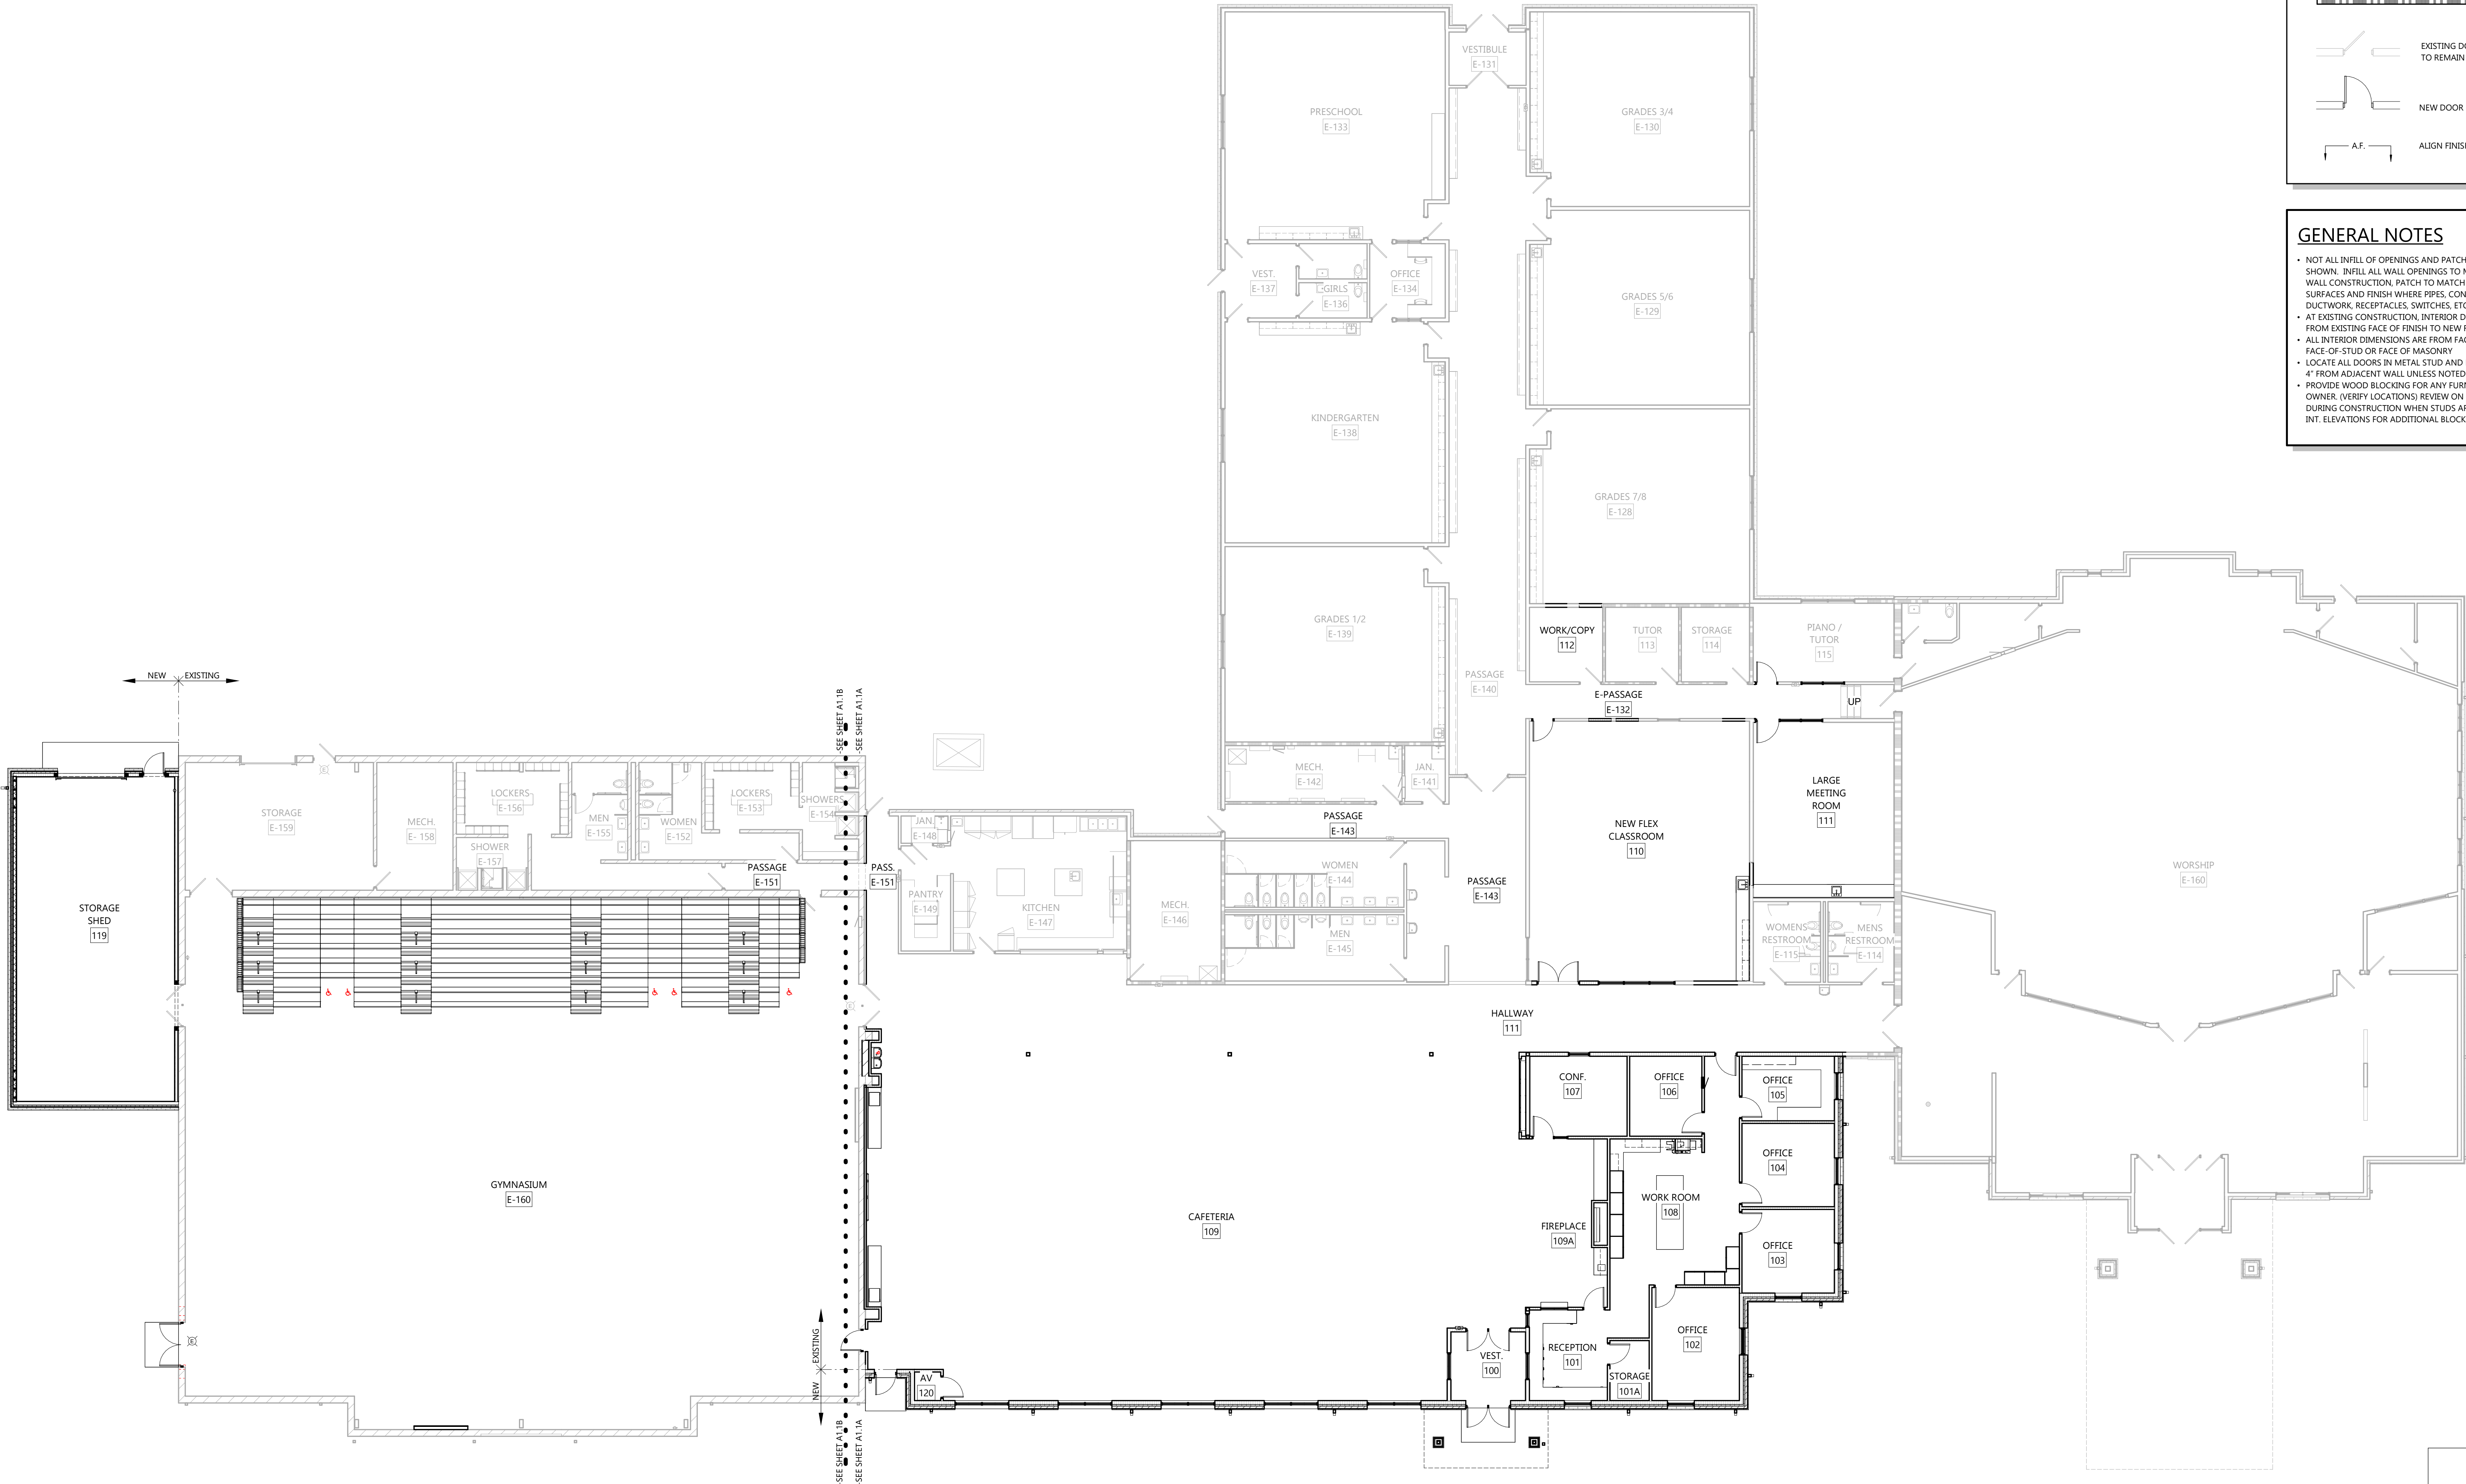

FLOOR PLAN - OVERALL

SCALE: 3/32" = 1'-0"
0' 8' 16'

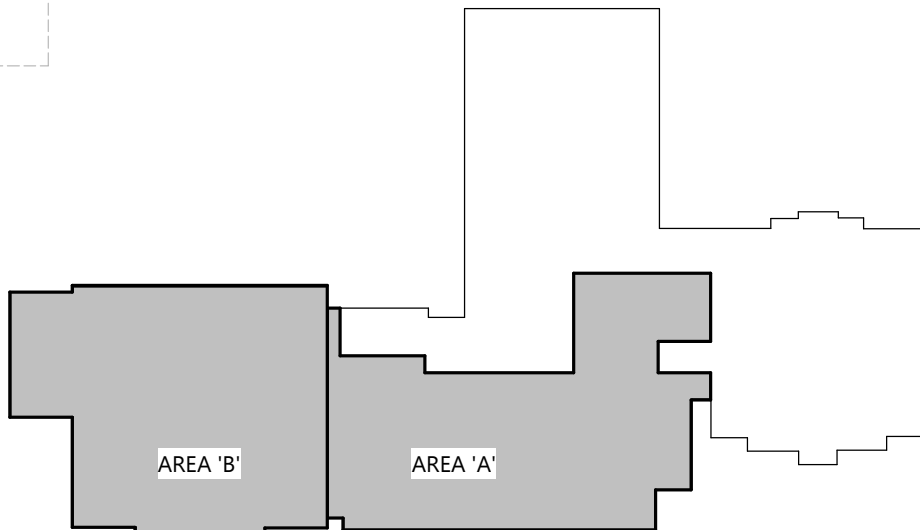

KEY PLAN

ARCHITECTURAL FLOOR PLAN - OVERALL




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387 CEMETERY ROAD • KIEL, WI 53042

ELIMINARY DATES



DEC. 12, 2025
JAN. 9, 2026

50315500

A1.1B

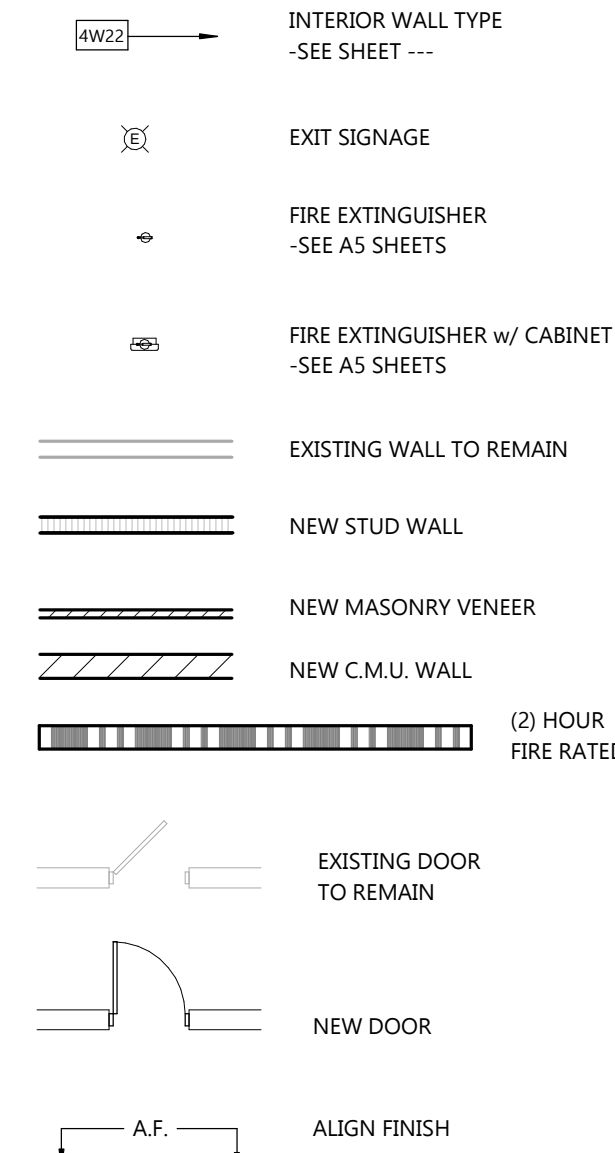

- NOT ALL INFILL OF OPENINGS AND PATCHING ARE SHOWN. INFILL ALL WALL OPENINGS TO MATCH EXISTING WALL CONSTRUCTION. PATCH TO MATCH ADJACENT SURFACES AND FINISH WHERE PIPES, CONDUIT, DUCTWORK, RECEPTACLES, SWITCHES, ETC. ARE REMOVED.
- AT EXISTING CONSTRUCTION, INTERIOR DIMENSIONS ARE FROM EXISTING FACE OF FINISH TO NEW FACE OF STUD.
- ALL INTERIOR DIMENSIONS ARE FROM FACE-OF-STUD TO FACE-OF-STUD OR FACE OF MASONRY
- LOCATE ALL DOORS IN METAL STUD AND MASONRY WALLS 4" FROM ADJACENT WALL UNLESS NOTED OTHERWISE.
- PROVIDE WOOD BLOCKING FOR ANY FURNISHINGS BY OWNER. (VERIFY LOCATIONS) REVIEW ON SITE W/ OWNER DURING CONSTRUCTION WHEN STUDS ARE EXPOSED. SEE INT. ELEVATIONS FOR ADDITIONAL BLOCKING LOCATIONS

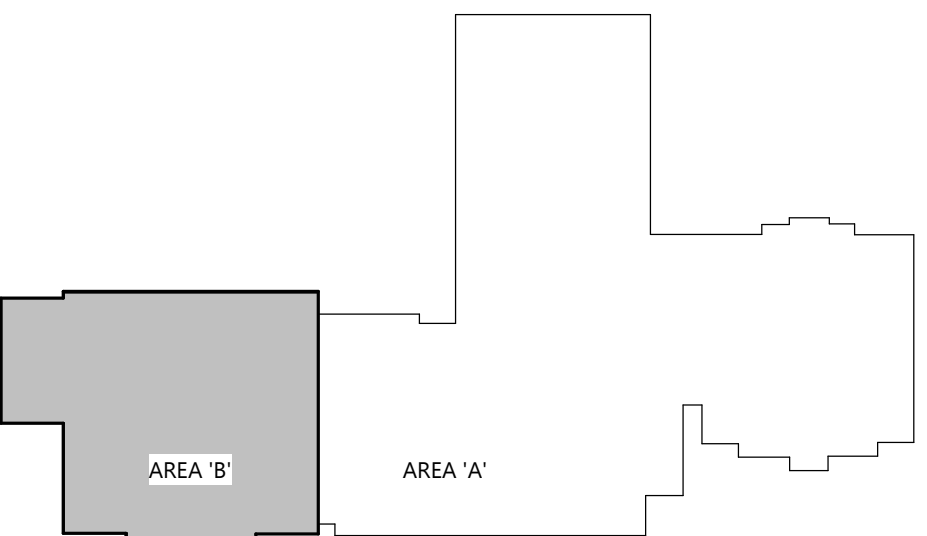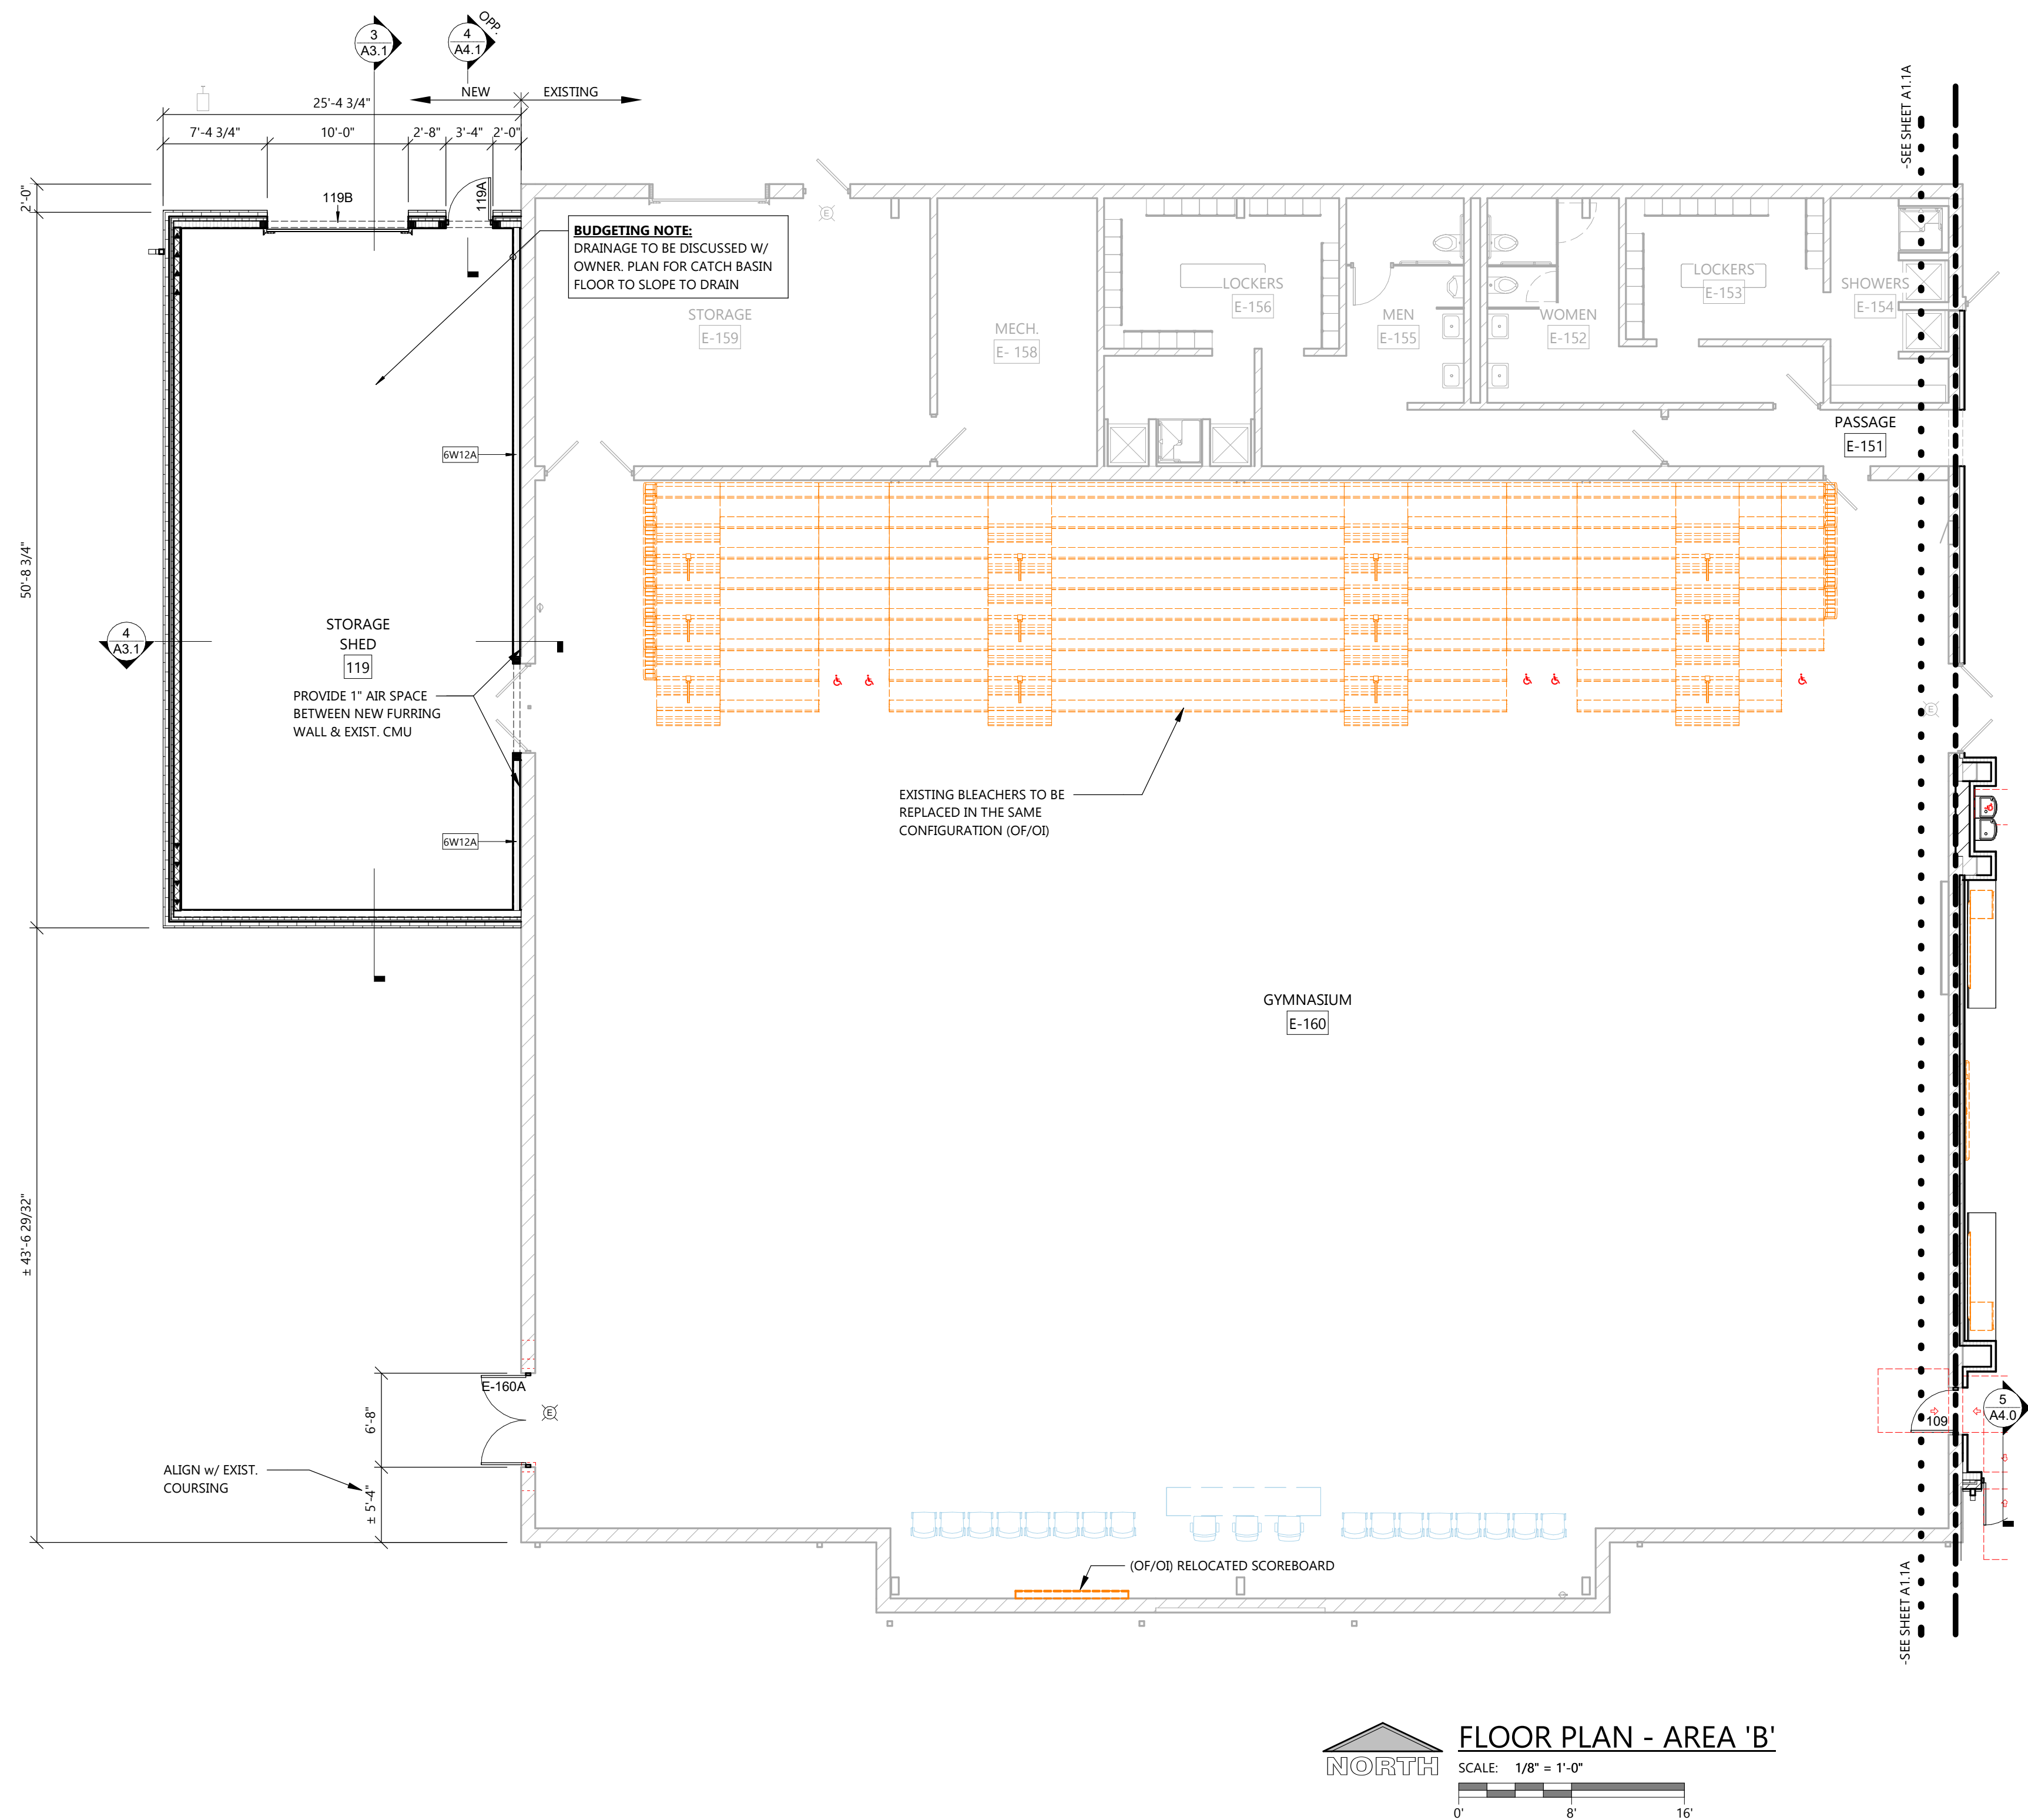


ARCHITECTURAL FLOOR PLAN - AREA 'B'

EXTERIOR MATERIAL KEY

- ARCHITECTURAL ASPHALT SHINGLES**
 MFR: MALARKEY ROOFING PRODUCTS
 PRODUCT: VISTA AR
 COLOR: TBD
 PROVIDE SAMPLES OF WEATHERED WOOD PLUS AND NATURAL WOOD FOR OWNER AND ARCHITECT APPROVAL
- PREFIN METAL**
 COLOR: MATCH EXISTING
 PROVIDE SAMPLES FOR APPROVAL
- EXTERIOR INSULATION FINISH SYSTEM (EIFS)**
 TEXTURE: MATCH EXISTING
 COLOR: MATCH EXISTING
 PROVIDE SAMPLES FOR APPROVAL
- CONCRETE SPLIT-FACE MASONRY UNITS**
 MFR:
 COLOR: PAINTED TO MATCH EXIST.
 PROVIDE PAINT SAMPLE FOR OWNER AND ARCHITECT APPROVAL
- BRICK VENEER**
 SEE SPEC.
- EXTERIOR SIDING PANEL**
 MFR: JAMES HARDIE
 COLOR: TBD / STUCCO FINISH
 PROVIDE SAMPLES FOR OWNER AND ARCHITECT APPROVAL

GENERAL NOTES


- EJ = EXPANSION JOINT (COLOR MATCH MASONRY)
(EXPANSION JOINT @ ALL INSIDE CORNERS)

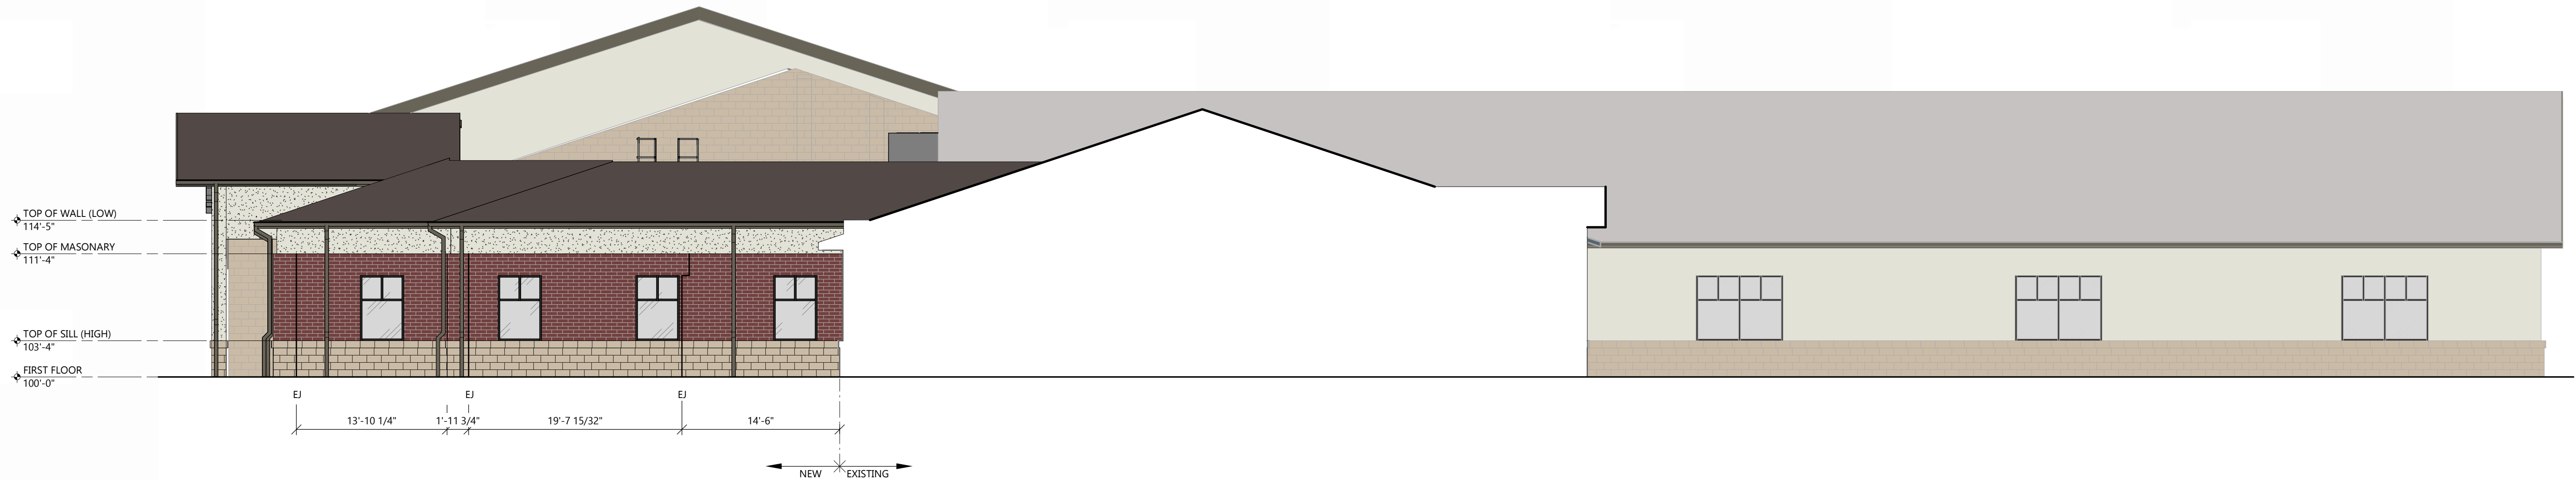

1
 A2.0
EAST ELEVATION
 SCALE: 1/8" = 1'-0"




2
 A2.0
SOUTH ELEVATION
 SCALE: 1/8" = 1'-0"

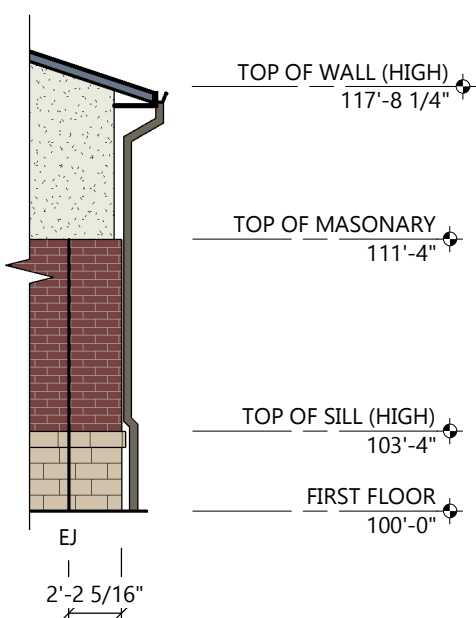


4
 A2.0
HIDDEN WEST ELEVATION
 SCALE: 1/8" = 1'-0"




3
 A2.0
SOUTH HIDDEN ELEVATION @ CANOPY
 SCALE: 1/8" = 1'-0"

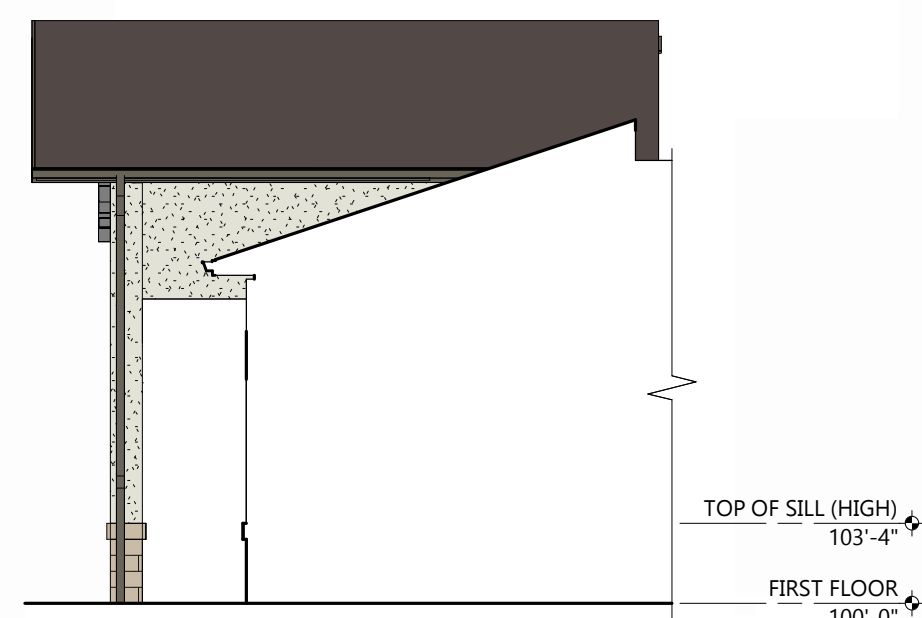

7
 A2.0
EAST HIDDEN ELEVATION @ CANOPY
 SCALE: 1/8" = 1'-0"

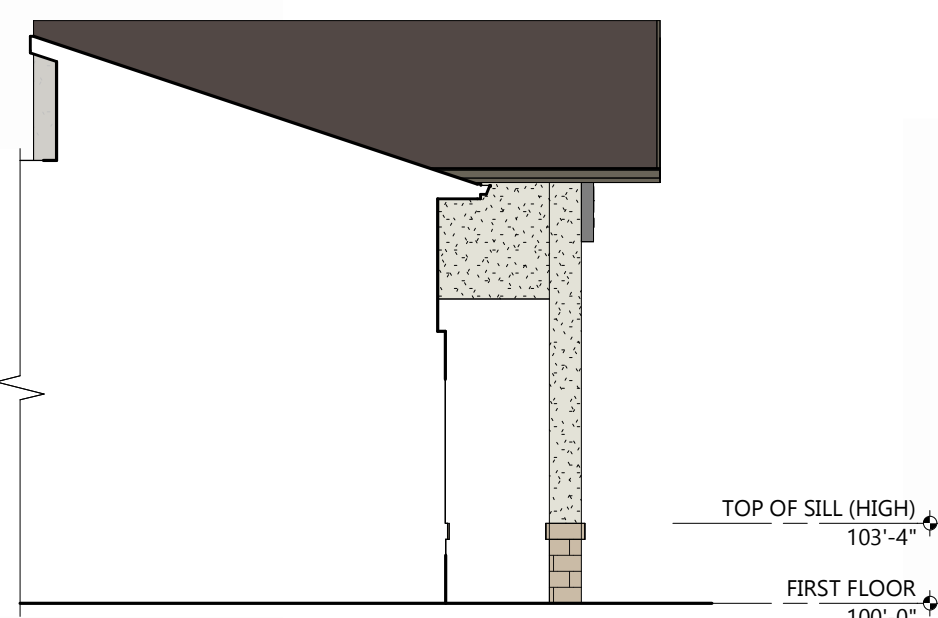

6
 A2.0
WEST HIDDEN ELEVATION @ CANOPY
 SCALE: 1/8" = 1'-0"

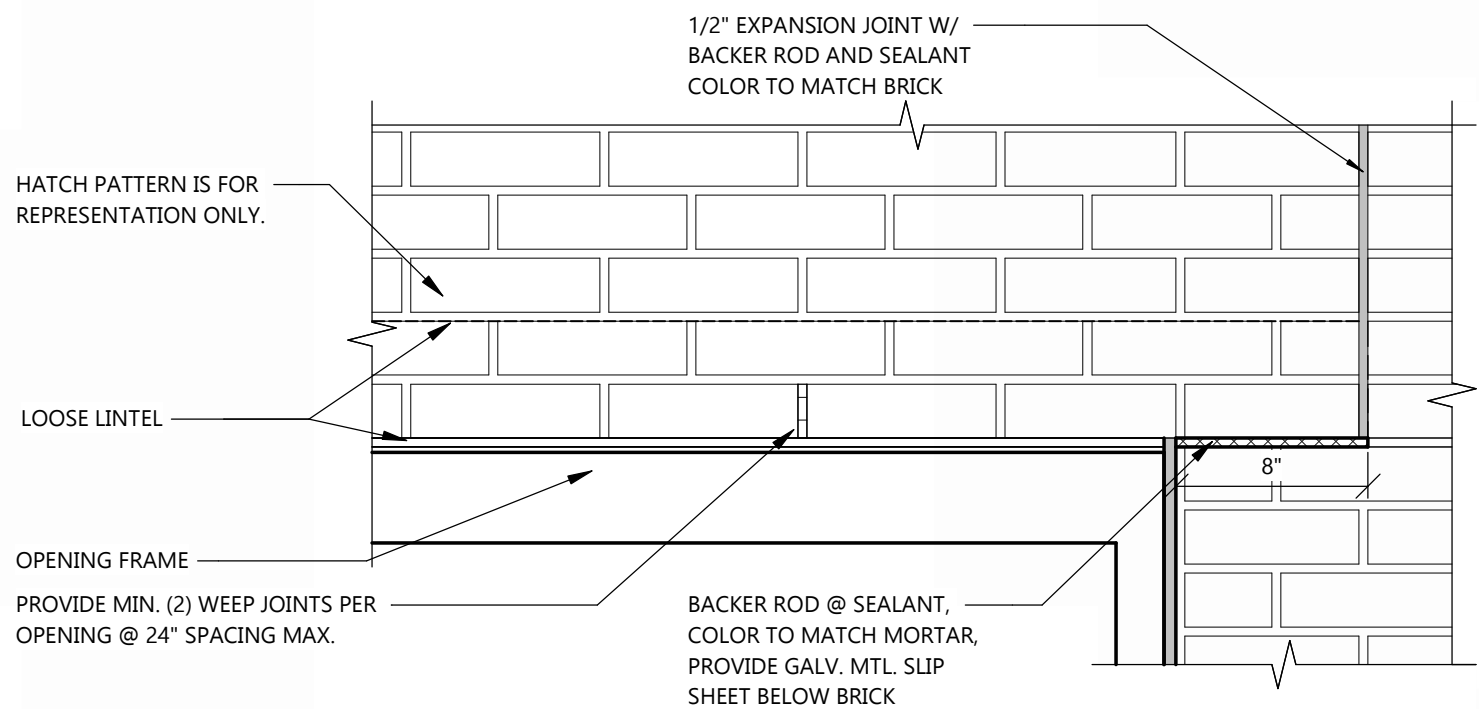


5
 A2.0
TYP. BRICK VENEER EXPANSION JOINT OVER OPENING
 NOT TO SCALE

MASONRY VENEER SPECIFICATION


- MANUFACTURER:** TBD
- COLOR SIZE:** UTILITY (MATCH EXISTING)
MORTAR COLOR TO BE SELECTED BY ARCHITECT FROM A FULL RANGE OF STANDARD COLORS. SEND PHYSICAL SAMPLES FOR APPROVAL.
- MOCK-UP:** CONTRACTOR TO PROVIDE A 64 S.F. MOCK-UP FOR APPROVAL FROM ARCH / OWNER. MOCK-UP TO INCLUDE BRICK, STONE SILL, AND CONTROL JOINT

ISOMETRIC VIEW


NOTE: ISOMETRIC VIEW IS FOR REFERENCE ONLY

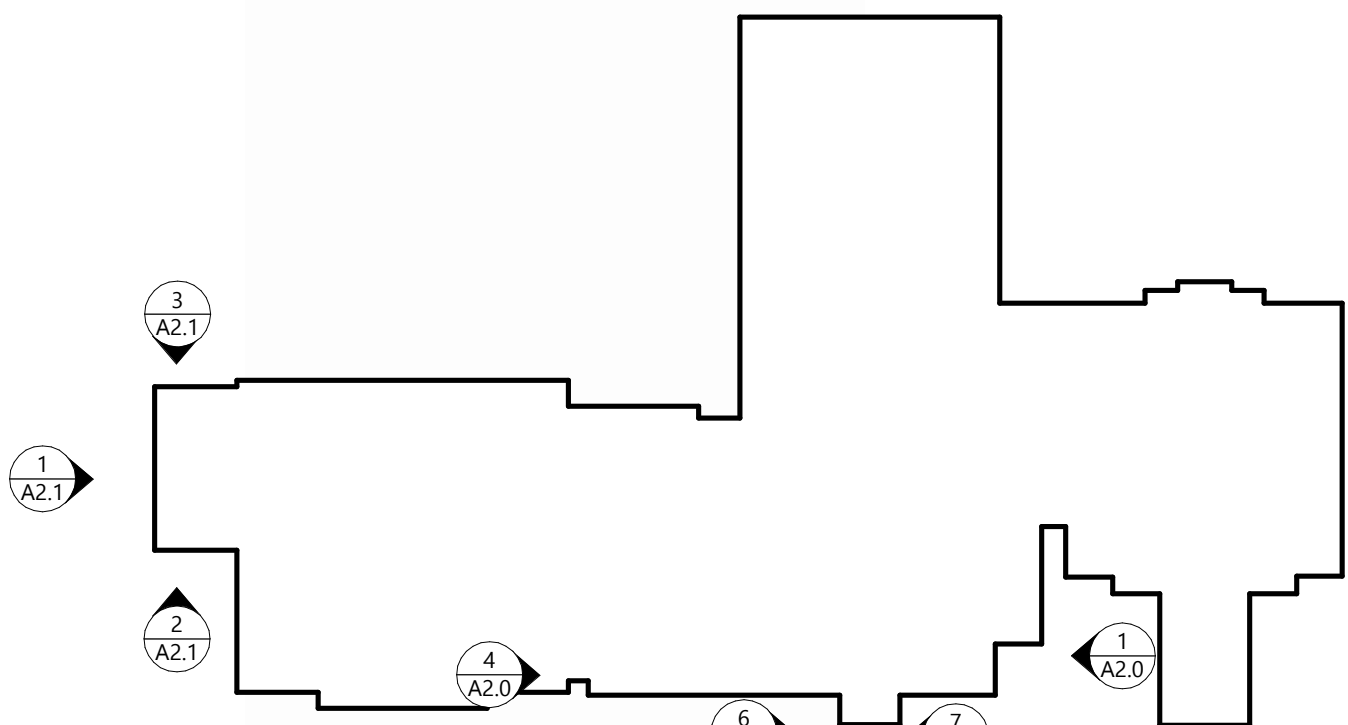


EXTERIOR ELEVATION KEY
 ARCHITECTURAL EXTERIOR ELEVATIONS

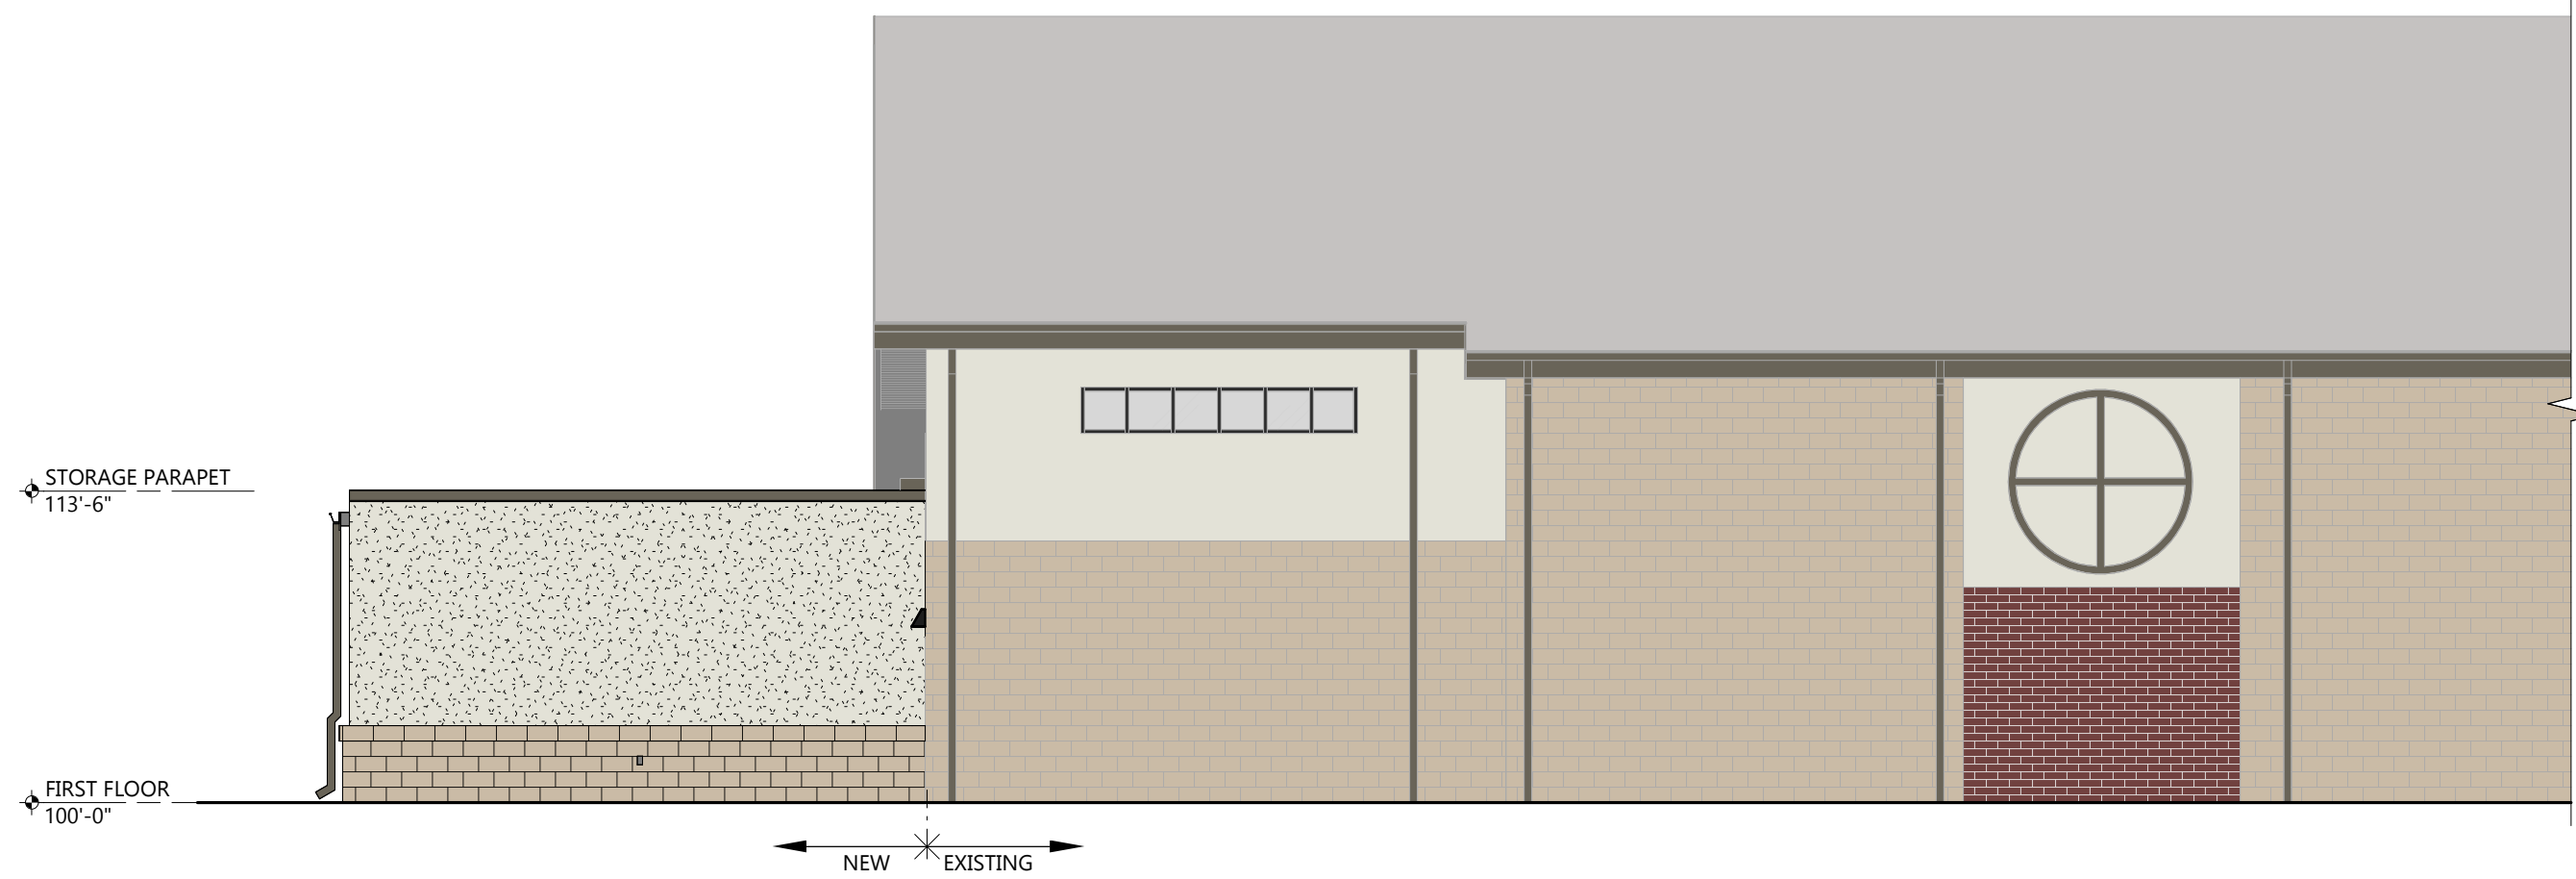


2 SOUTH ELEVATION
A2.1
SCALE: 1/8" = 1'-0"

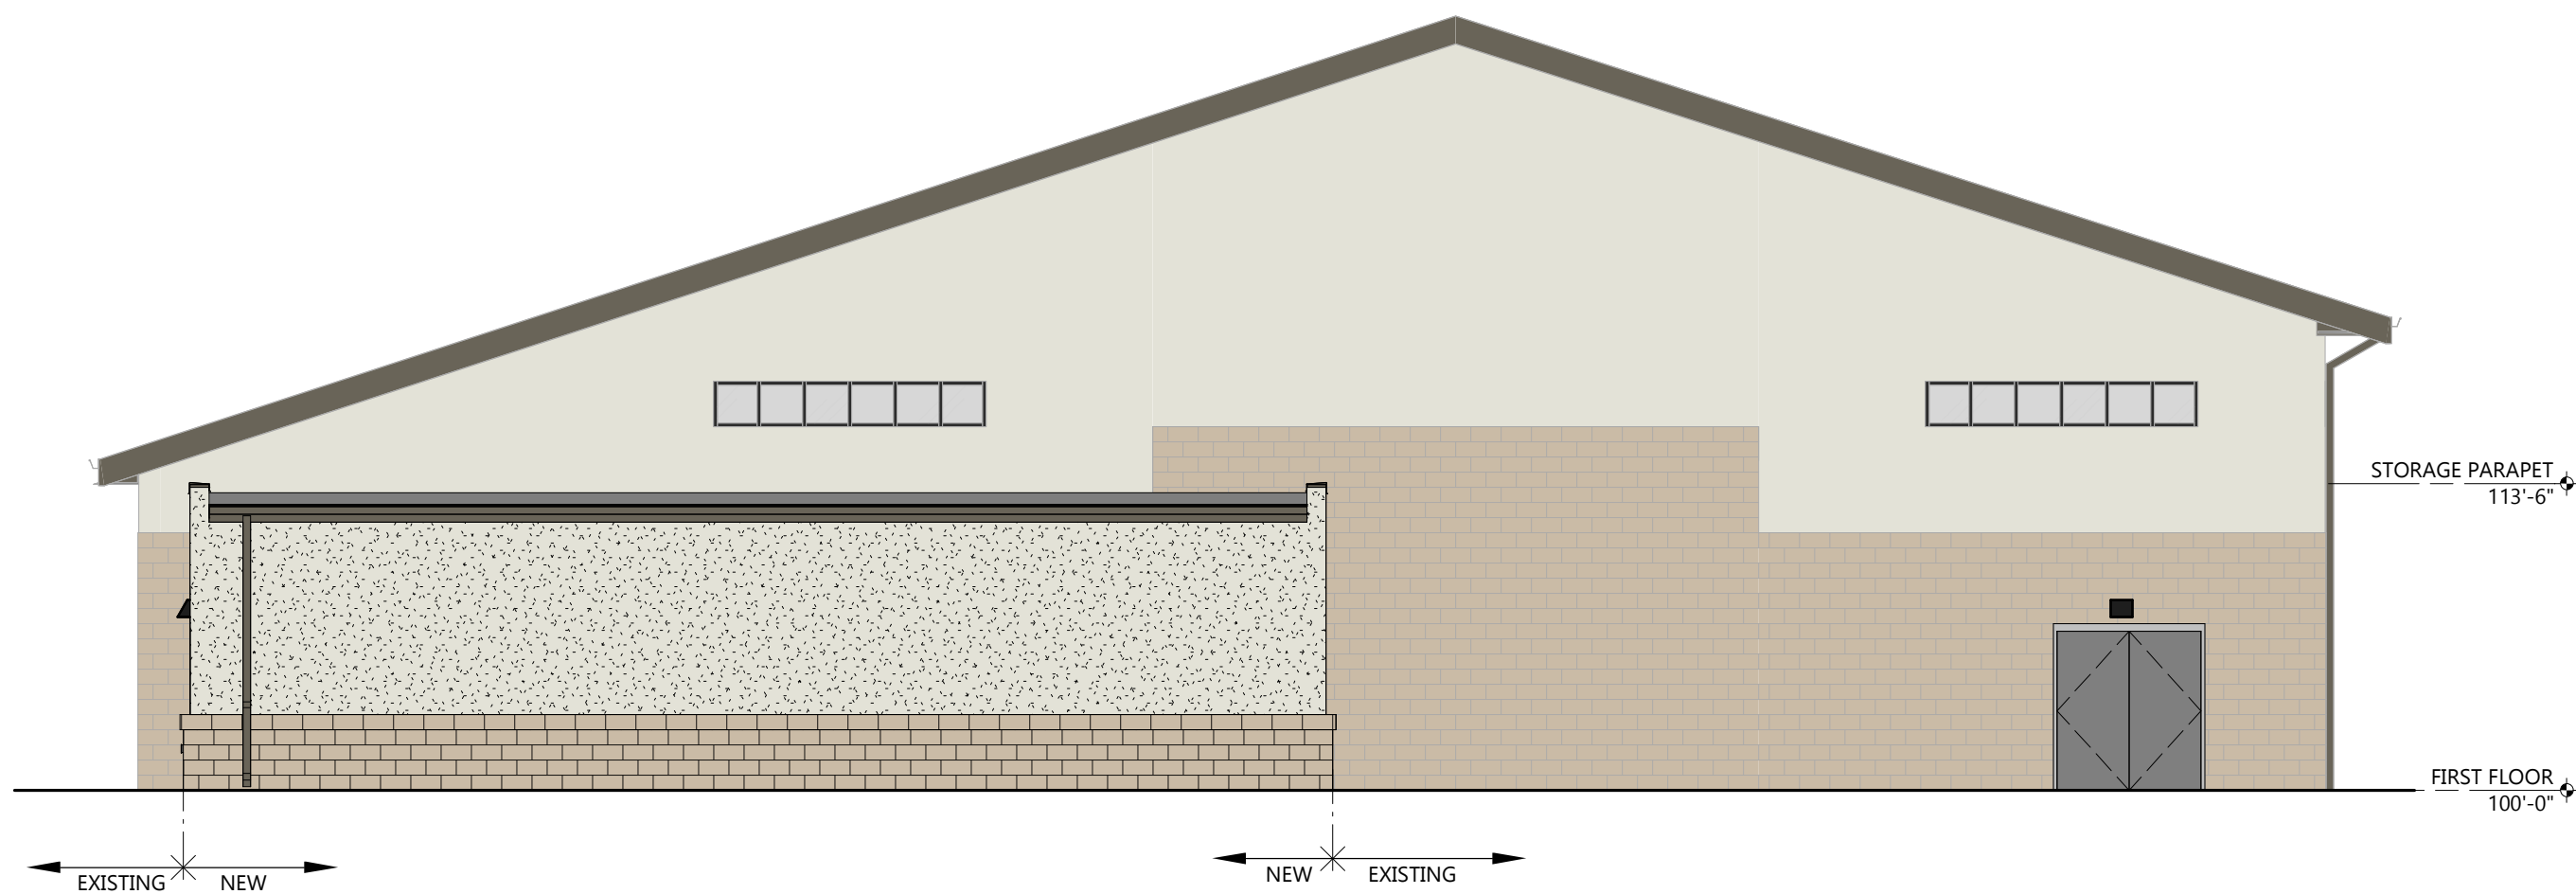


1 WEST ELEVATION - STORAGE
A2.1
SCALE: 1/8" = 1'-0"

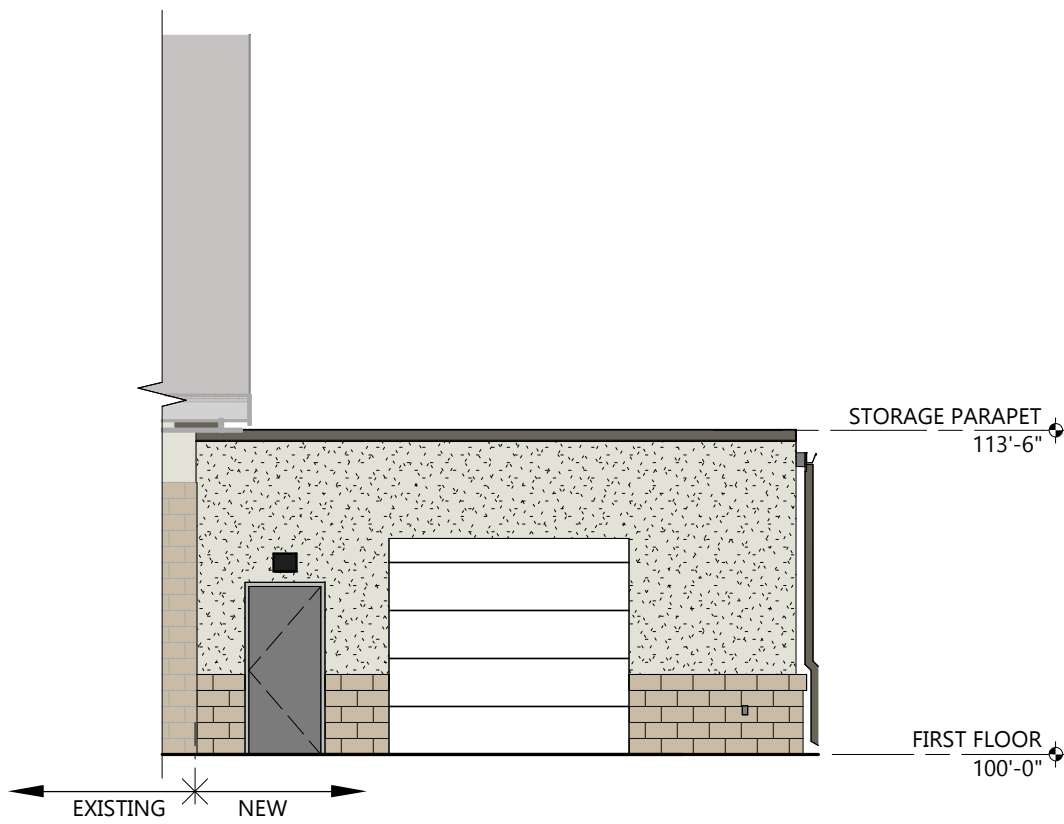

3 NORTH ELEVATION
A2.1
SCALE: 1/8" = 1'-0"

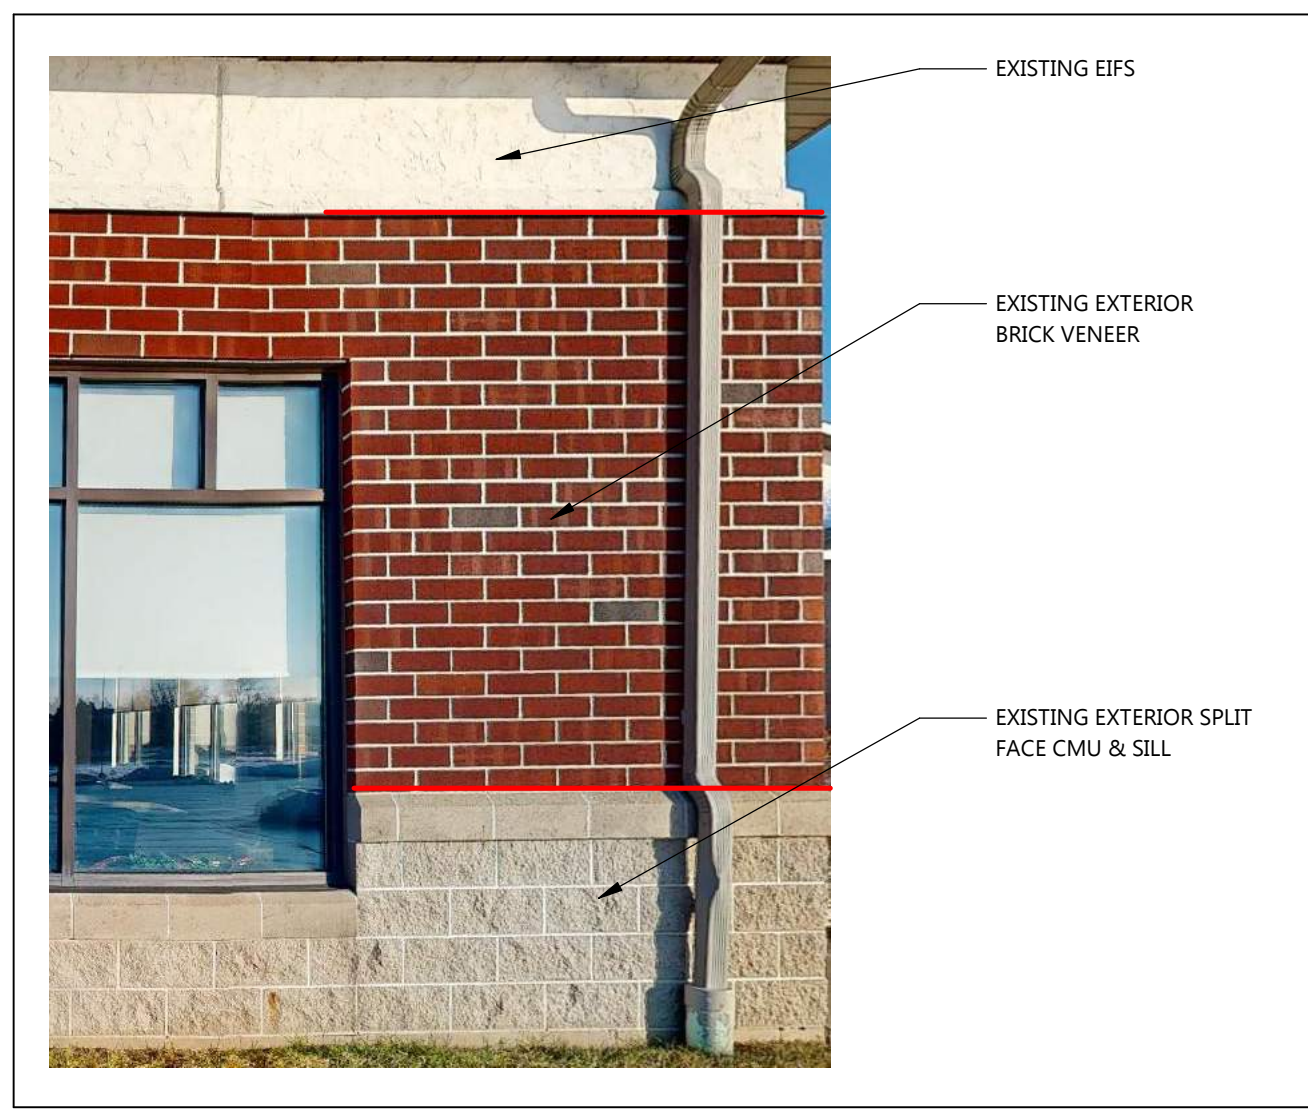

EXISTING EXTERIOR MATERIAL REFERENCE

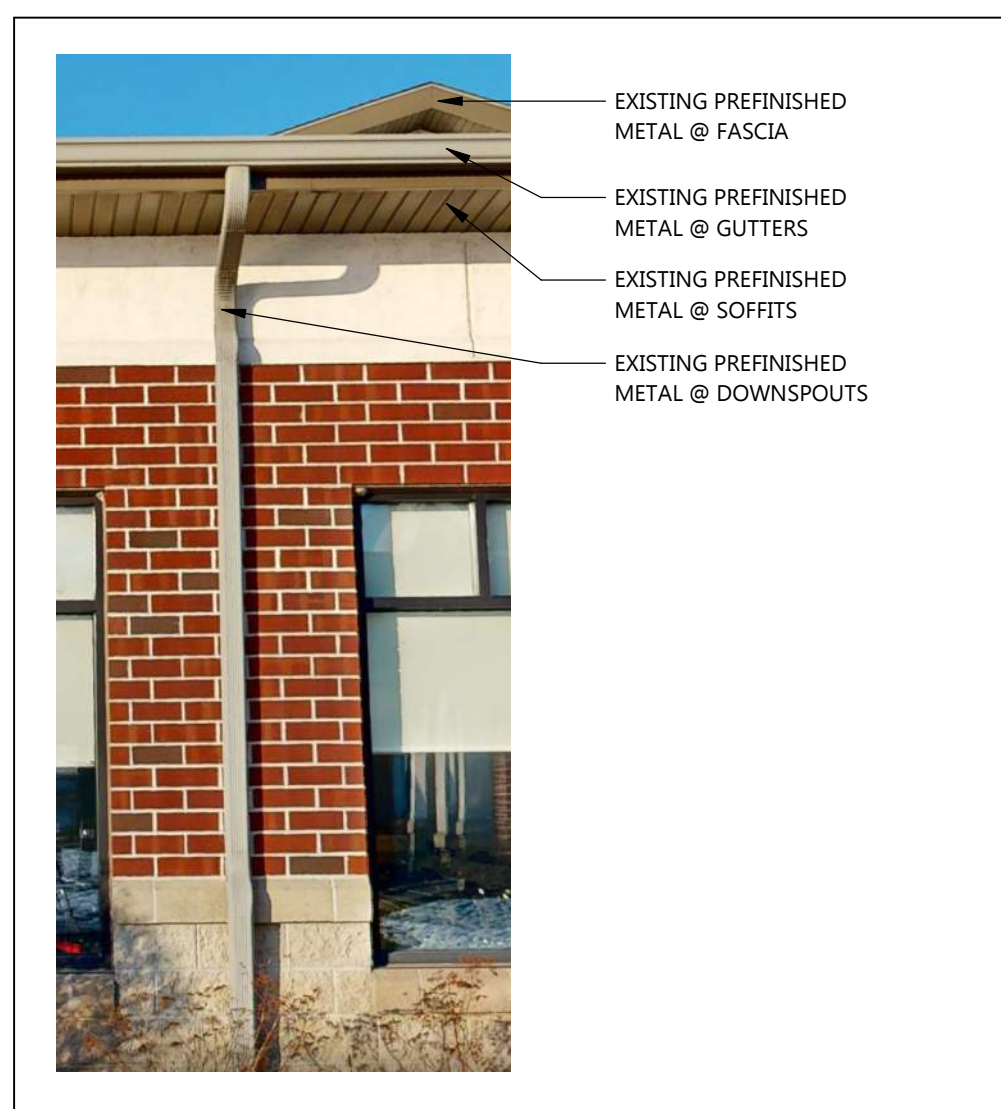

EXISTING PREFIN METAL COLOR REFERENCE

EXTERIOR MATERIAL KEY

- ARCHITECTURAL ASPHALT SHINGLES**
MFR: MALARKEY ROOFING PRODUCTS
PRODUCT: VISTA AR
COLOR: T8D
*PROVIDE SAMPLES OF WEATHERED WOOD PLUS AND NATURAL WOOD FOR OWNER AND ARCHITECT APPROVAL
- PREFIN METAL**
COLOR: MATCH EXISTING
*PROVIDE SAMPLES FOR APPROVAL
- EXTERIOR INSULATION FINISH SYSTEM (EIFS)**
TEXTURE: MATCH EXISTING
COLOR: MATCH EXISTING
*PROVIDE SAMPLES FOR APPROVAL
- CONCRETE SPLIT-FACE MASONRY UNITS**
MFR:
COLOR: PAINTED TO MATCH EXIST.
*PROVIDE PAINT SAMPLE FOR OWNER AND ARCHITECT APPROVAL
- BRICK VENEER**
SEE SPEC.
- EXTERIOR SIDING PANEL**
MFR: JAMES HARDIE
COLOR: T8D / STUCCO FINISH
*PROVIDE SAMPLES FOR OWNER AND ARCHITECT APPROVAL



Always a Better Plan

100 Camelot Drive
Fond du Lac, WI 54935
920-926-9800
excelengineer.com

PROJECT INFORMATION

PROPOSED ADDITION FOR:
TRINITY LUTHERAN CHURCH
387 CEMETERY ROAD • KIEL, WI 53042

PROFESSIONAL SEAL

PRELIMINARY DATES


DEC. 12, 2025
JAN. 9, 2026

JOB NUMBER

250315500

SHEET NUMBER

A2.1

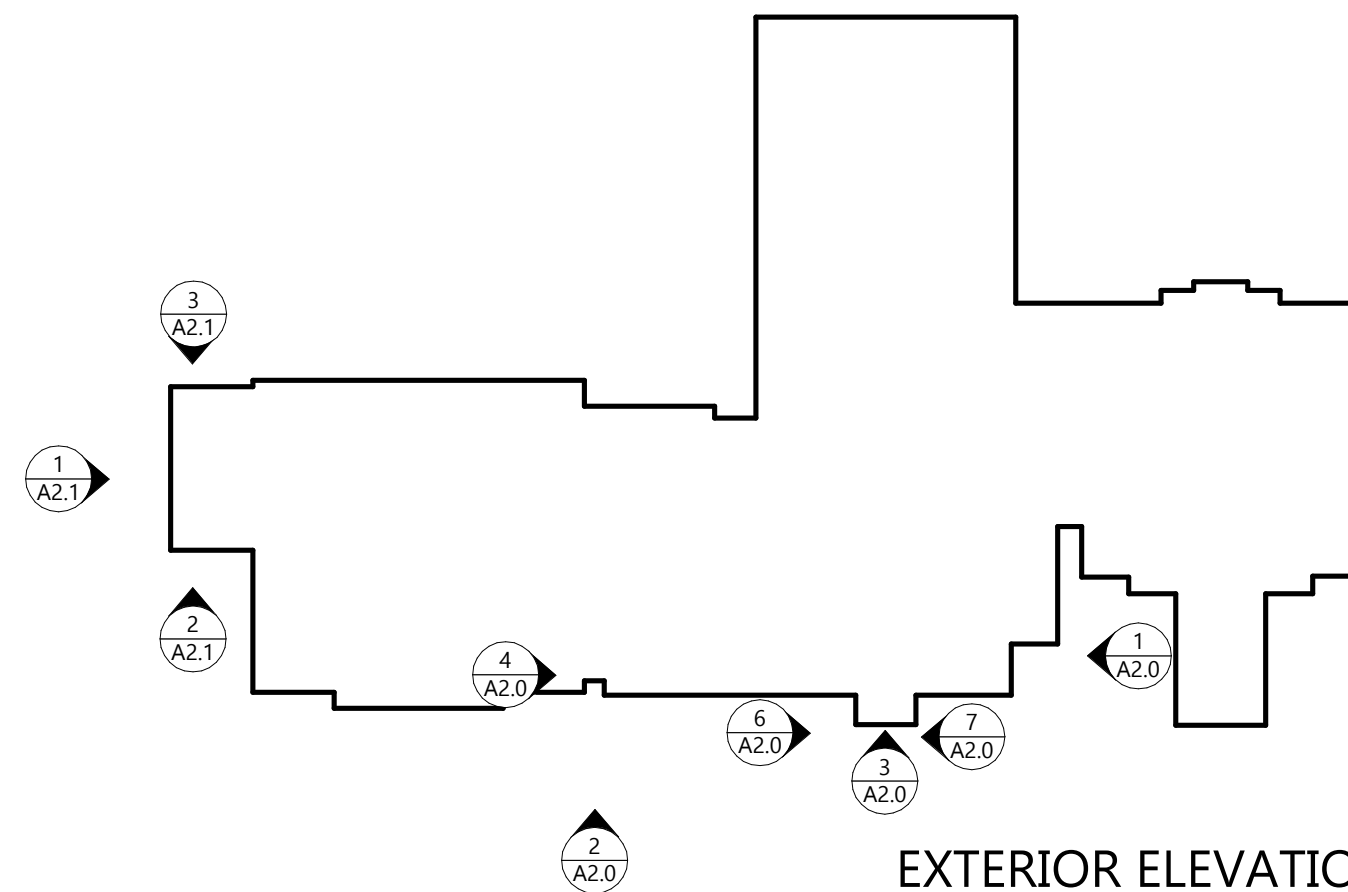

EXTERIOR ELEVATION KEY
ARCHITECTURAL EXTERIOR ELEVATIONS

NOT FOR CONSTRUCTION



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201 Corporate Drive, Beaver Dam WI 53916
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PROJECT NO. 22701001

DRAWN BY: T. DAVIS

SURVEYOR: T. DAVIS

FILE NO. 22701001

SHEET NO. 1 of 2

OWNER:

DANIEL H AND RUTH E KUESTER
REVOCABLE LIVING TRUST
22610 STH 57
KIEL, WI 53042

MANITOWOC COUNTY CERTIFIED SURVEY MAP


- LEGEND**
- FD. SECTION CORNER
 - FD. 1" IRON PIPE
 - SET. 3/4" BY 18" IRON ROD - 1.50 LBS / FT
 - SET MAG NAIL
 - FD. 2" IRON PIPE
 - (xx) RECORDED AS VALUE

SAID PARCEL IS SUBJECT TO
ALL EASEMENTS RECORDED
AND UNRECORDED

LOT 1 AREA EXCLUDING ROW:	47,759± SQ. FT. 1.096± ACRES
TOTAL ROW AREA:	2,640± SQ. FT. 0.061± ACRES
TOTAL LOT 1 AREA:	50,399± SQ. FT. 1.157± ACRES



A SURVEY OF UNPLATTED LANDS LOCATED IN THE SE 1/4 OF
THE SE 1/4 OF SECTION 29, T.17N., R.21E., TOWN OF
SCHLESWIG, MANITOWOC COUNTY, WISCONSIN.

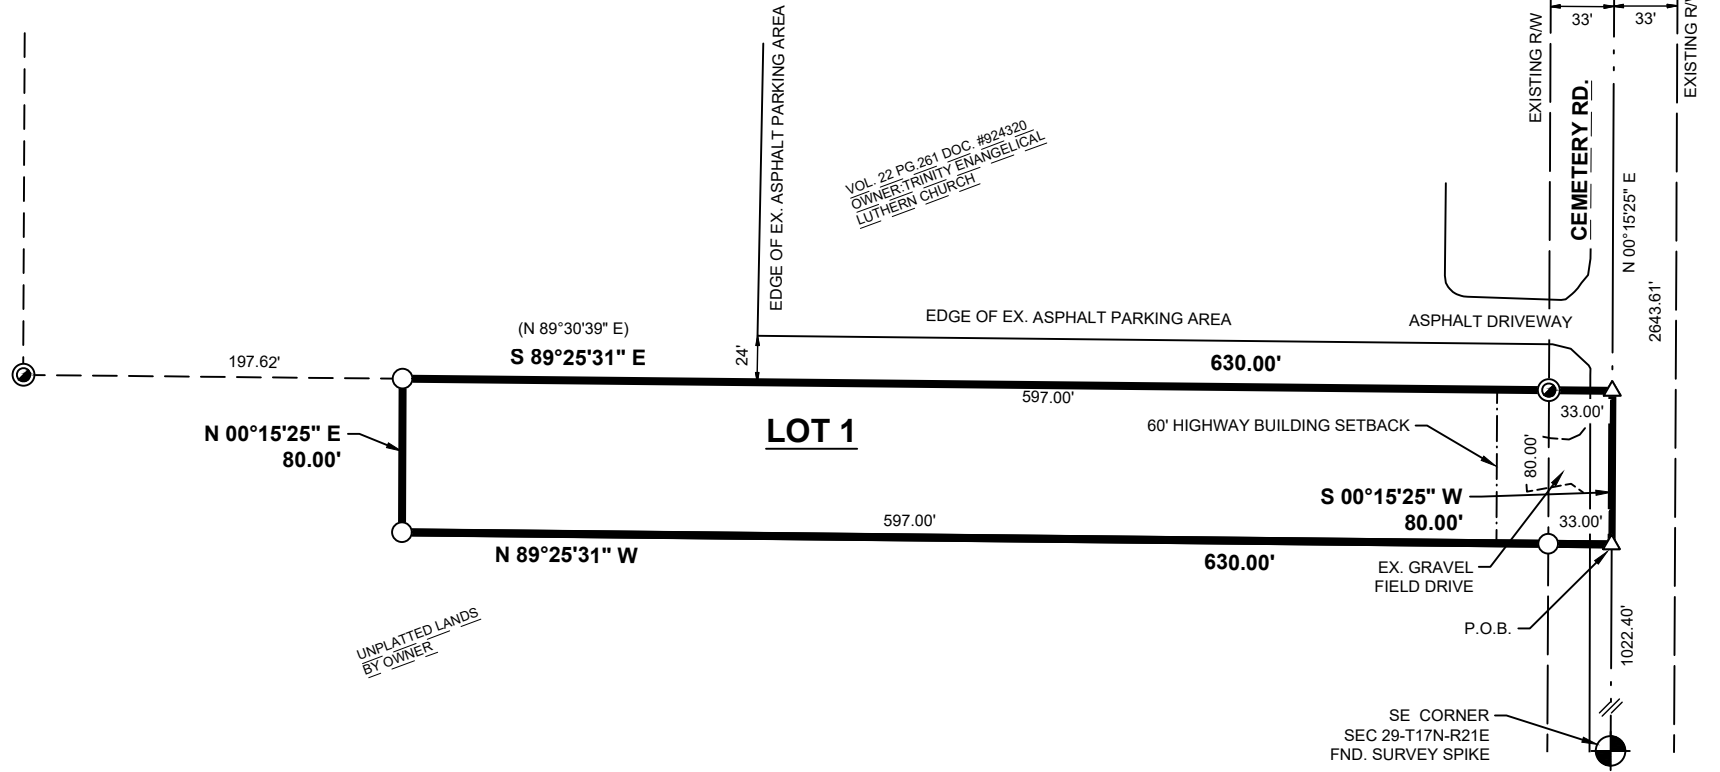



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PROJECT NO. 22701001

DRAWN BY: T. DAVIS

SURVEYOR: T. DAVIS

FILE: 22701001 KUESTER CSM.dwg

SHEET NO. 2 OF 2

MANITOWOC COUNTY CERTIFIED SURVEY MAP

A SURVEY OF UNPLATTED LANDS LOCATED IN THE SE 1/4 OF THE SE 1/4 OF SECTION 29, T.17N., R.21E., TOWN OF SCHLESWIG, MANITOWOC COUNTY, WISCONSIN.

SURVEYOR'S CERTIFICATION

I, Timothy B. Davis, Professional Land Surveyor of the State of Wisconsin do hereby certify that by order of Daniel H. and Ruth E. Kuester Revocable Living Trust , I have surveyed and mapped lands being part of the SE 1/4 of the SE 1/4 of Section 29, all in T.17N., R.21E., Town of Schleswig, Manitowoc County, Wisconsin and being more particularly described as follows:

LEGAL DESCRIPTION

COMMENCING at the SE 1/4 Corner of Section 29, Town 17 North, Range 21 East in the Town of Schleswig, Manitowoc County, Wisconsin, thence N 00°15'25" E, along the east line of the SE 1/4 of said Section 29, 1022.40 feet the **POINT OF BEGINNING**;
thence N 89°25'31" W, 630.00 feet; thence N 00°15'25" E, 80.00 feet to a point on the south line of CSM Volume 22, Page 261-262 recorded as Document #924320 in the Manitowoc County Register of Deeds; thence S 89°25'31" E along the south line of said CSM Volume 22, Page 261-262 , 630.00 feet to a point on the east line of the SE 1/4 of Section 29; thence S 00°15'25" W along the east line of the SE 1/4 of said Section 29, 80.00 feet to the **POINT OF BEGINNING**.

Said parcel contains 50,399 sq ft / 1.157 acres more or less
I further certify that this map is a correct representation of all of the exterior boundaries of the land surveyed, that I have complied with the provisions of Chapter 236.34 of the Wisconsin State Statutes to the best of my knowledge and belief.

Timothy B Davis, PLS S-4045

OWNER'S CERTIFICATE

As owner, I do hereby certify that we have caused the land described on this Certified Survey Map to be surveyed, mapped, and divided as represented hereon. Said owner further certifies that this Certified Survey Map is required by S.236.34, Wisconsin Statutes to be submitted to the City of Kiel for approval.

In witness whereof, authorized representative of the Daniel H. and Ruth E. Kuester Revocable Living Trust have caused these documents to be signed this

_____ day of _____, 20_____.

(Print)

(Signature)

Authorized Representative of the Daniel H. and Ruth E. Kuester Revocable Living Trust

State of Wisconsin) SS

_____ County) SS

Personally came before me on this ____ day of _____, 20_____, the above named authorized representative of the City of Kiel to me known to be the person who executed the foregoing instrument, and acknowledged the same.

Notary Public, _____ County, Wisconsin
My Commission Expires _____

CITY PLANNING COMMISSION CERTIFICATE:

By virtue of extraterritorial rights, the City of Kiel hereby approves this Certified Survey Map

City of Kiel Representative

Date

AGENDA - PLAN COMMISSION

DATE: February 5, 2026
TIME: 6:00 P.M.
LOCATION: City Council Chambers, Kiel City Hall
621 Sixth St., Kiel, Wis.
MEMBERS: Mayor Bob Hennings, Alderperson Kathy Schuette,
Pete Tarnowski, Jim Fromm, John Moritz, Eric
Volland, Gina Ziegelbauer

- 1) Mayor Bob Hennings - Call to order
- 2) Pledge of Allegiance
- 3) Roll Call
- 4) Approve minutes of the January 15, 2026, Plan Commission Meeting
- 5) Public Comment
- 6) Consideration of Certified Survey Map for Kuester Property
- 7) Consideration and Possible Action on approval of Trinity Lutheran School addition
- 8) Set a public hearing for the ordinance amendments to the Kiel Zoning Code 17.44 and
17.32
- 9) Adjournment

Bob Hennings, Mayor
Prepared by Ryan Pafford, City Administrator